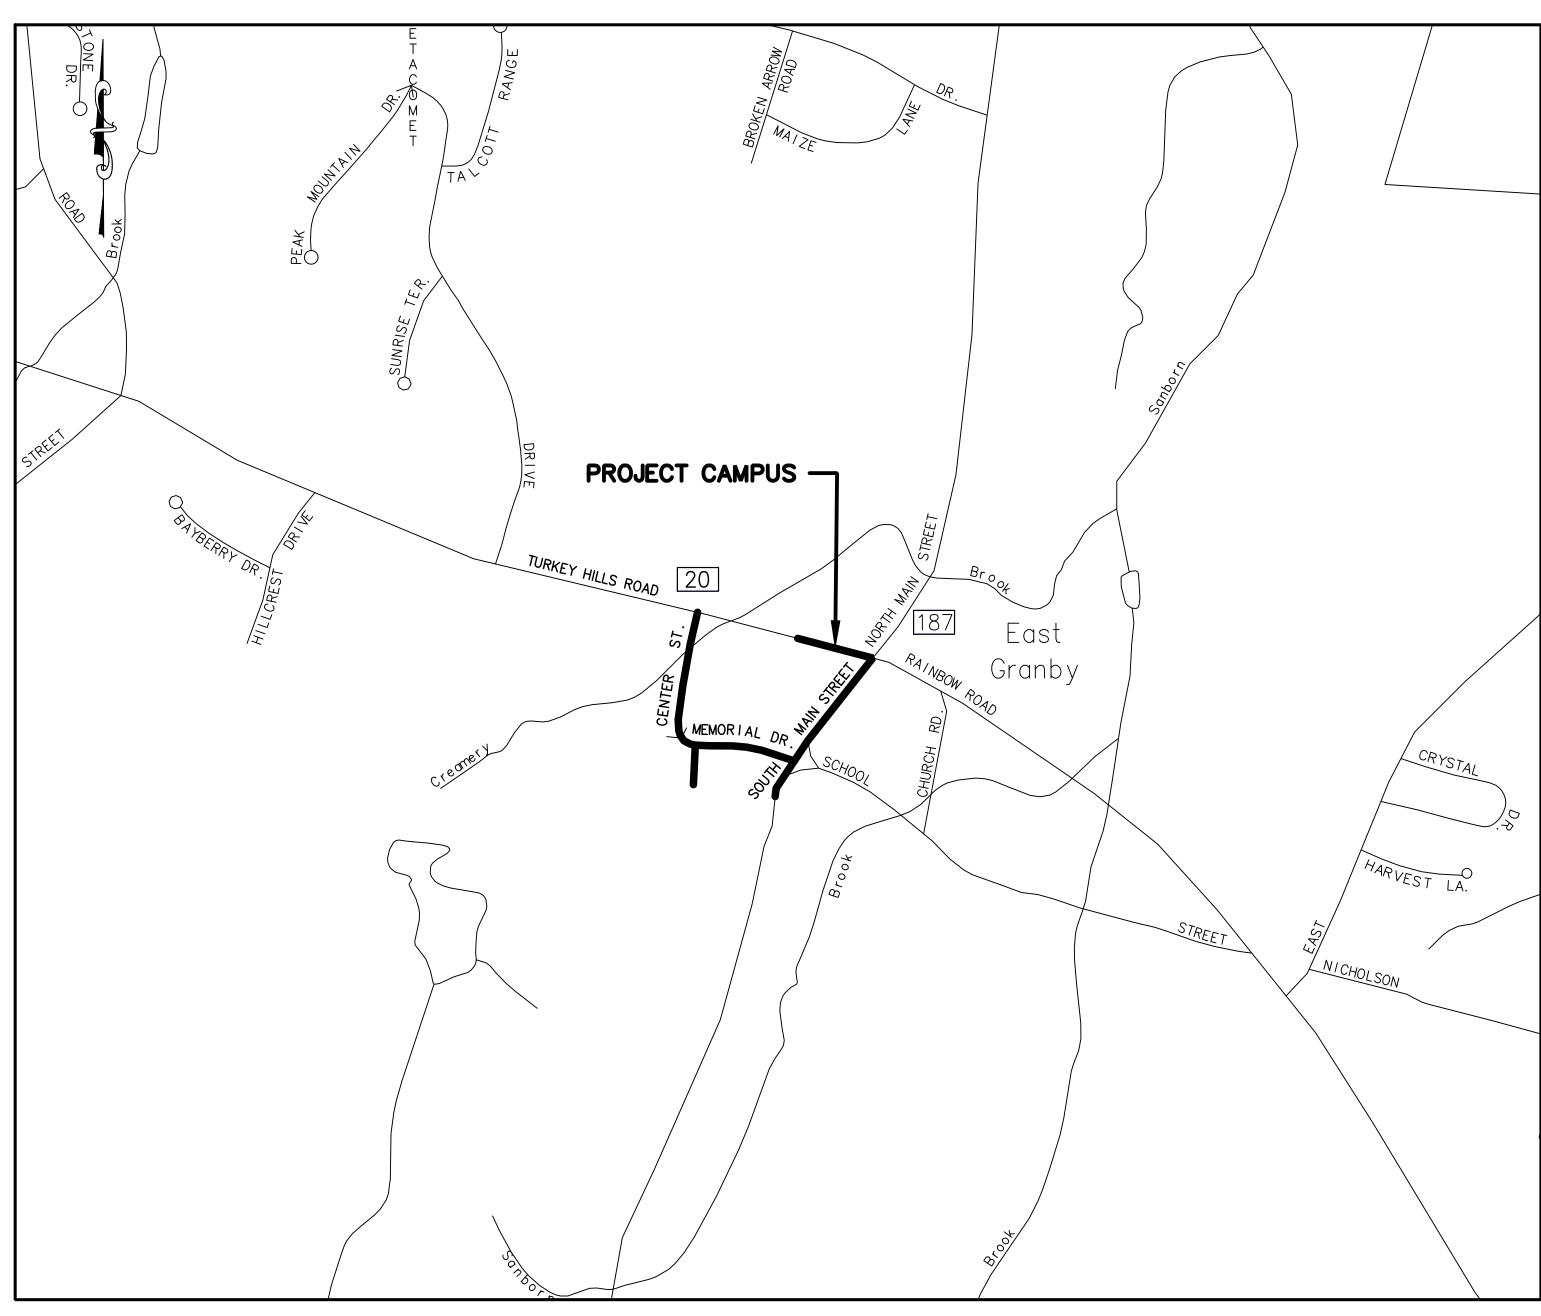
TOWN CAMPUS SIDEWALK CONNECTIONS

TOWN CAMPUS EAST GRANBY, CONNECTICUT COMMUNITY CONNECTIVITY GRANT PROGRAM PROJECT # 0170-3513GR



LOCATION MAP

SCALE: 1"=500'

DRAWING LIST

SHEET NUMBER DRAWING TITLE COVER SHEET

01-01 COVER SHEET 03-01 - 03-02 EXISTING CONDITIONS PLANS 11-01 - 11-02 SITE LAYOUT PLANS

11-01 - 11-02 SITE LAYOUT PLA 12-01 - 12-02 GRADING PLANS

18-01 - 18-02 SOIL EROSION AND SEDIMENT CONTROL PLANS

19-01 - 19-12 CONSTRUCTION NOTES & DETAILS

TOWN OF EAST GRANBY

9 Center Street

East Granby, Connecticut 06026

P: (860)-653-2576

SITE ENGINEER

B&B ENGINEERING LLC

15 Research Drive Suite 3

Woodbridge, Connecticut 06525

T: (203) 881-8145

BOARD OF SELECTMEN

Eden Wimpfheimer, First Selectwoman Nicole Sokolowski, Executive Assistant

Steven Hall, Selectman

Amanda Thompson, Selectman

PLANNING & ZONING DEPARMENT

Robin Newton, AICP, CZEO

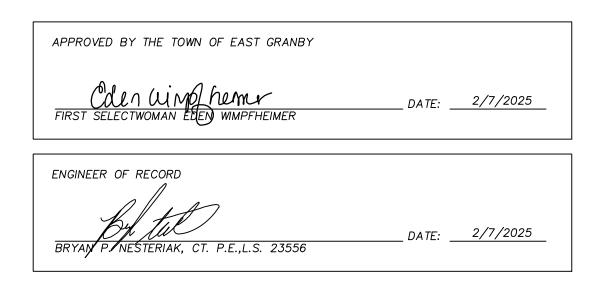
Director of Planning & Economic Development

GENERAL ENGINEERING NOTES

- 1. PROJECT SPECIFICATIONS ENTITLED "PROJECT MANUAL FOR TOWN CAMPUS SIDEWALK CONNECTIONS CCGP #0170-3513GR; DATED 2/7/2025; PREPARED FOR TOWN OF EAST GRANBY; PREPARED BY B&B ENGINEERING LLC., WOODBRIDGE, CT"
- 2. THE STATE OF CONNECTICUT DEPARTMENT OF TRANSPORTATION STANDARD SPECIFICATIONS FOR ROADS, BRIDGE, FACILITIES AND INCIDENTAL CONSTRUCTION (FORM 819) AND ALL SUPPLEMENTS THERETO SHALL GOVERN THIS PROJECT.
- TOWN CAMPUS TO BE MAINTAINED BY THE TOWN OF EAST GRANBY.

GENERAL SURVEY NOTES

BOUNDARY AND TOPOGRAPHIC INFORMATION OBTAINED FROM A FIELD SURVEY PREPARED BY ACCURATE LAND SURVEYING LLC., WOODBRIDGE, CT. TOPOGRAPHIC CONTOURS AND ELEVATIONS REFER TO NAVD 88 DATUM.

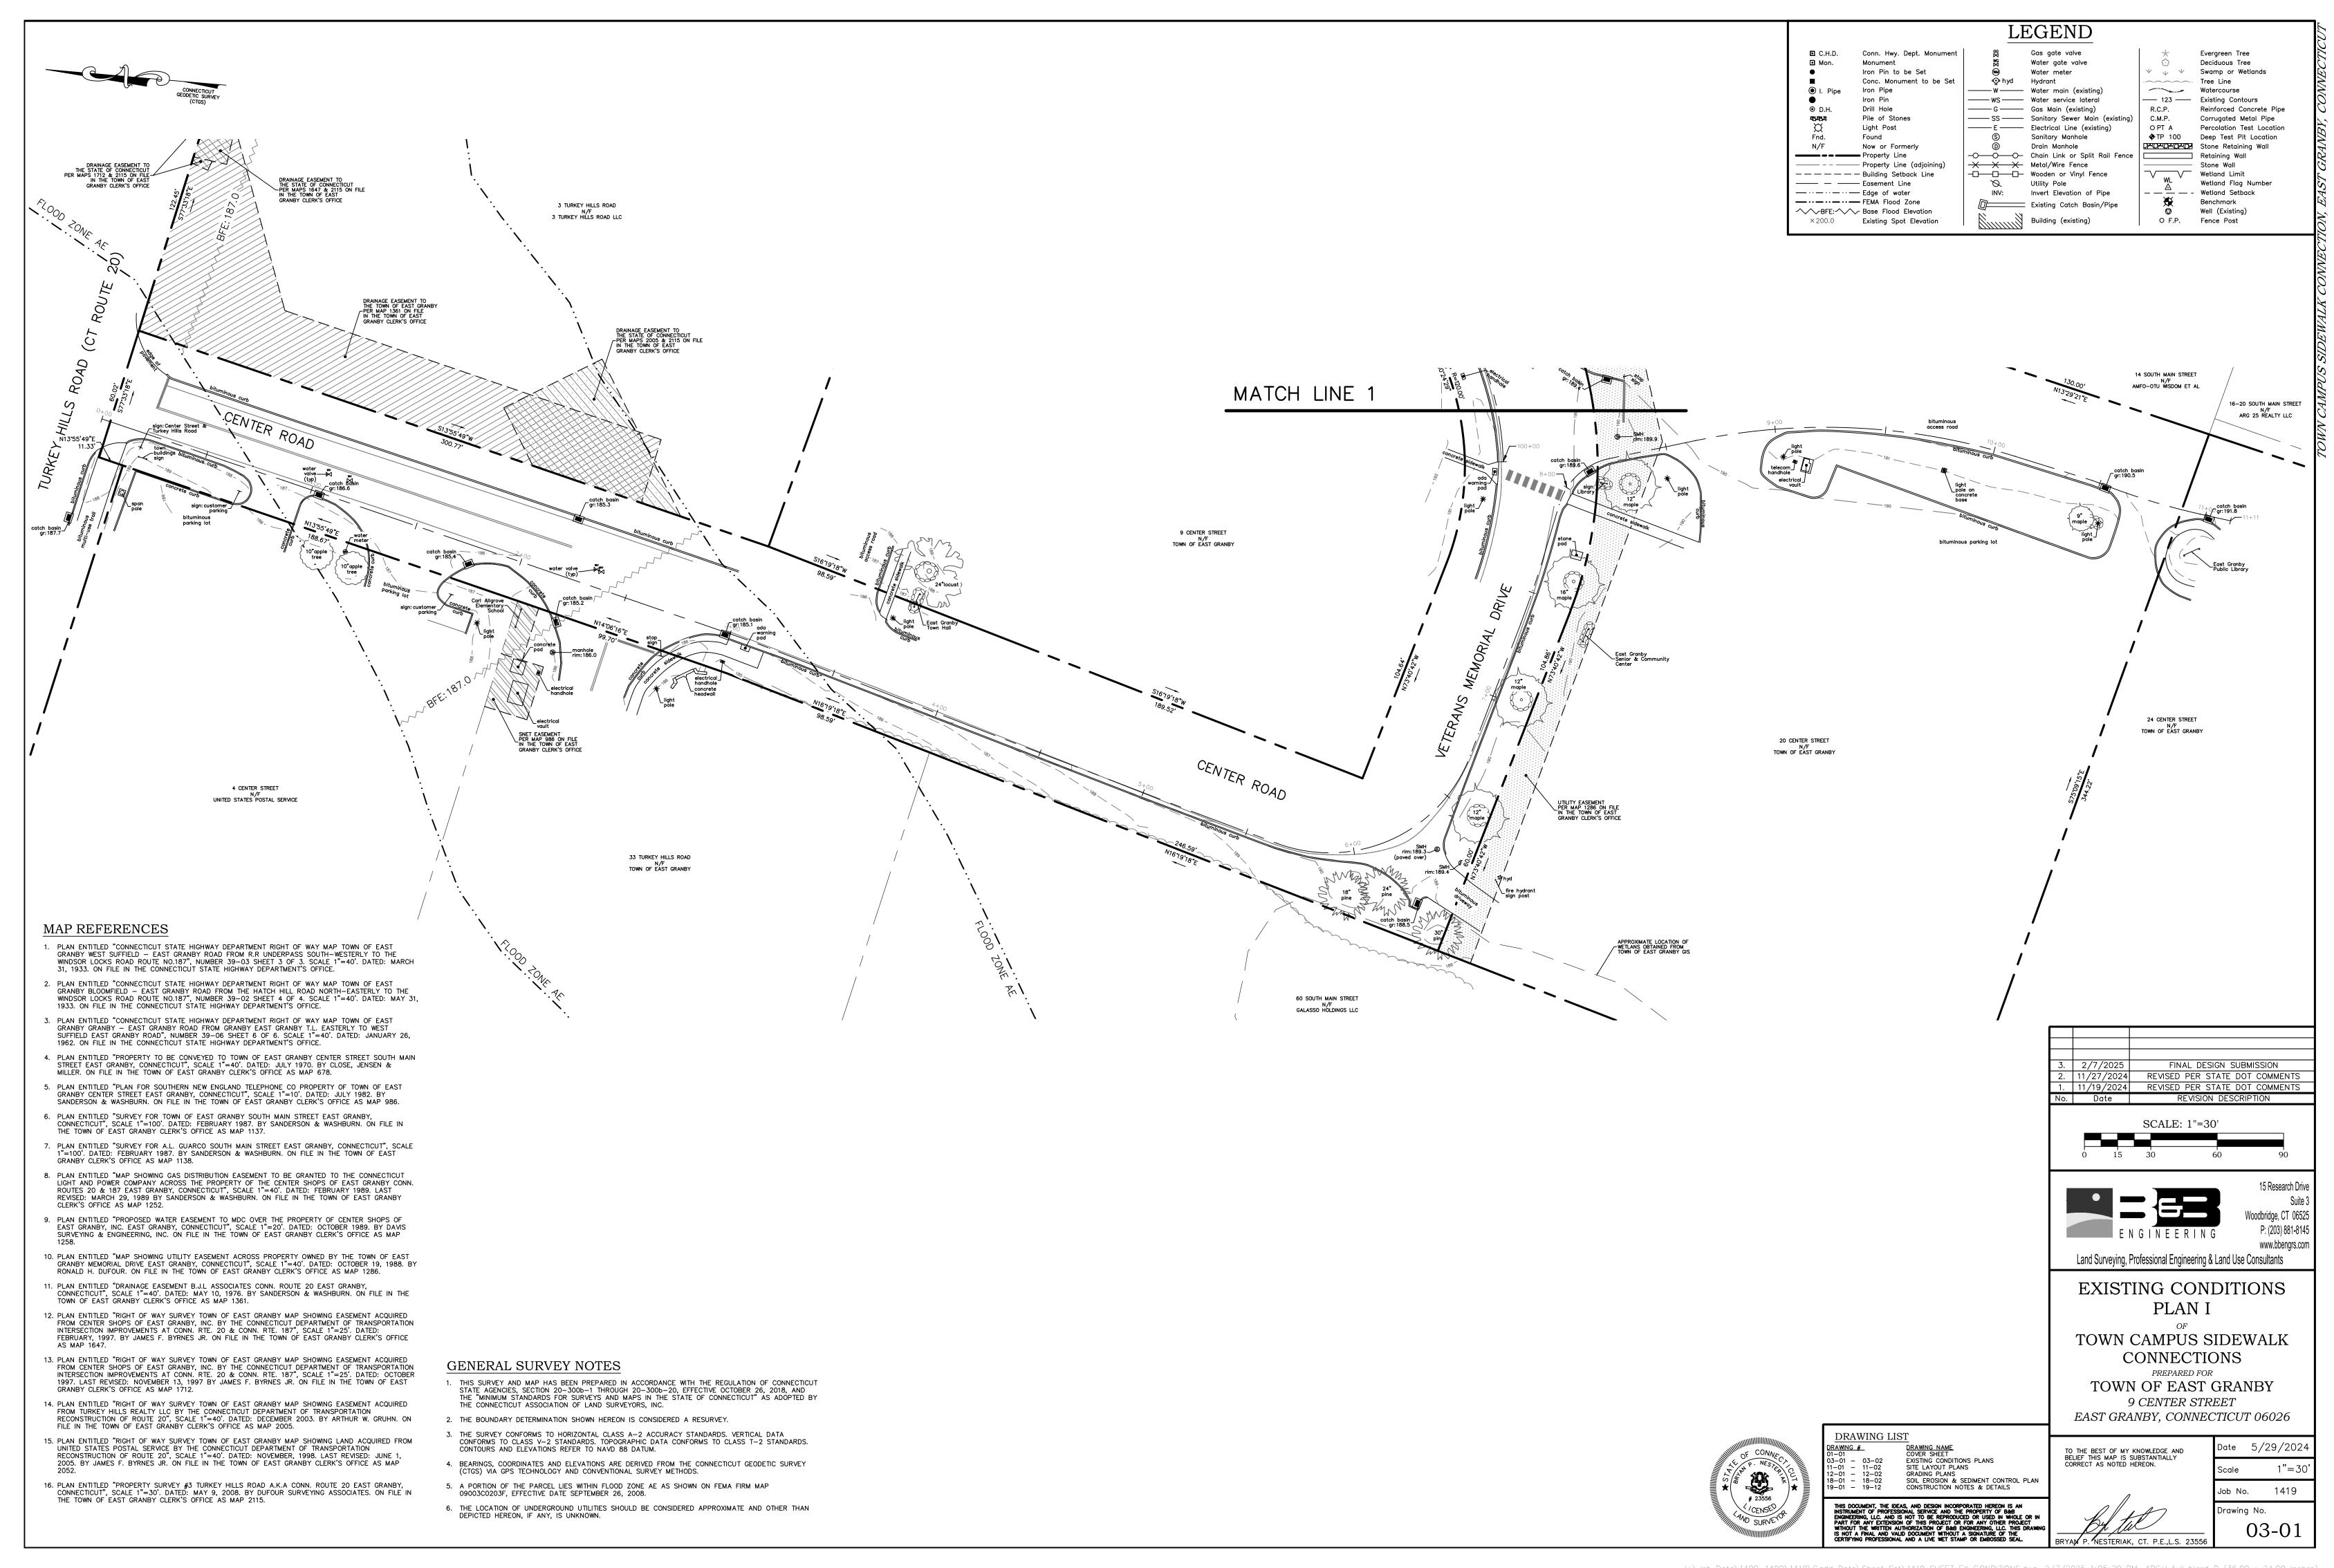


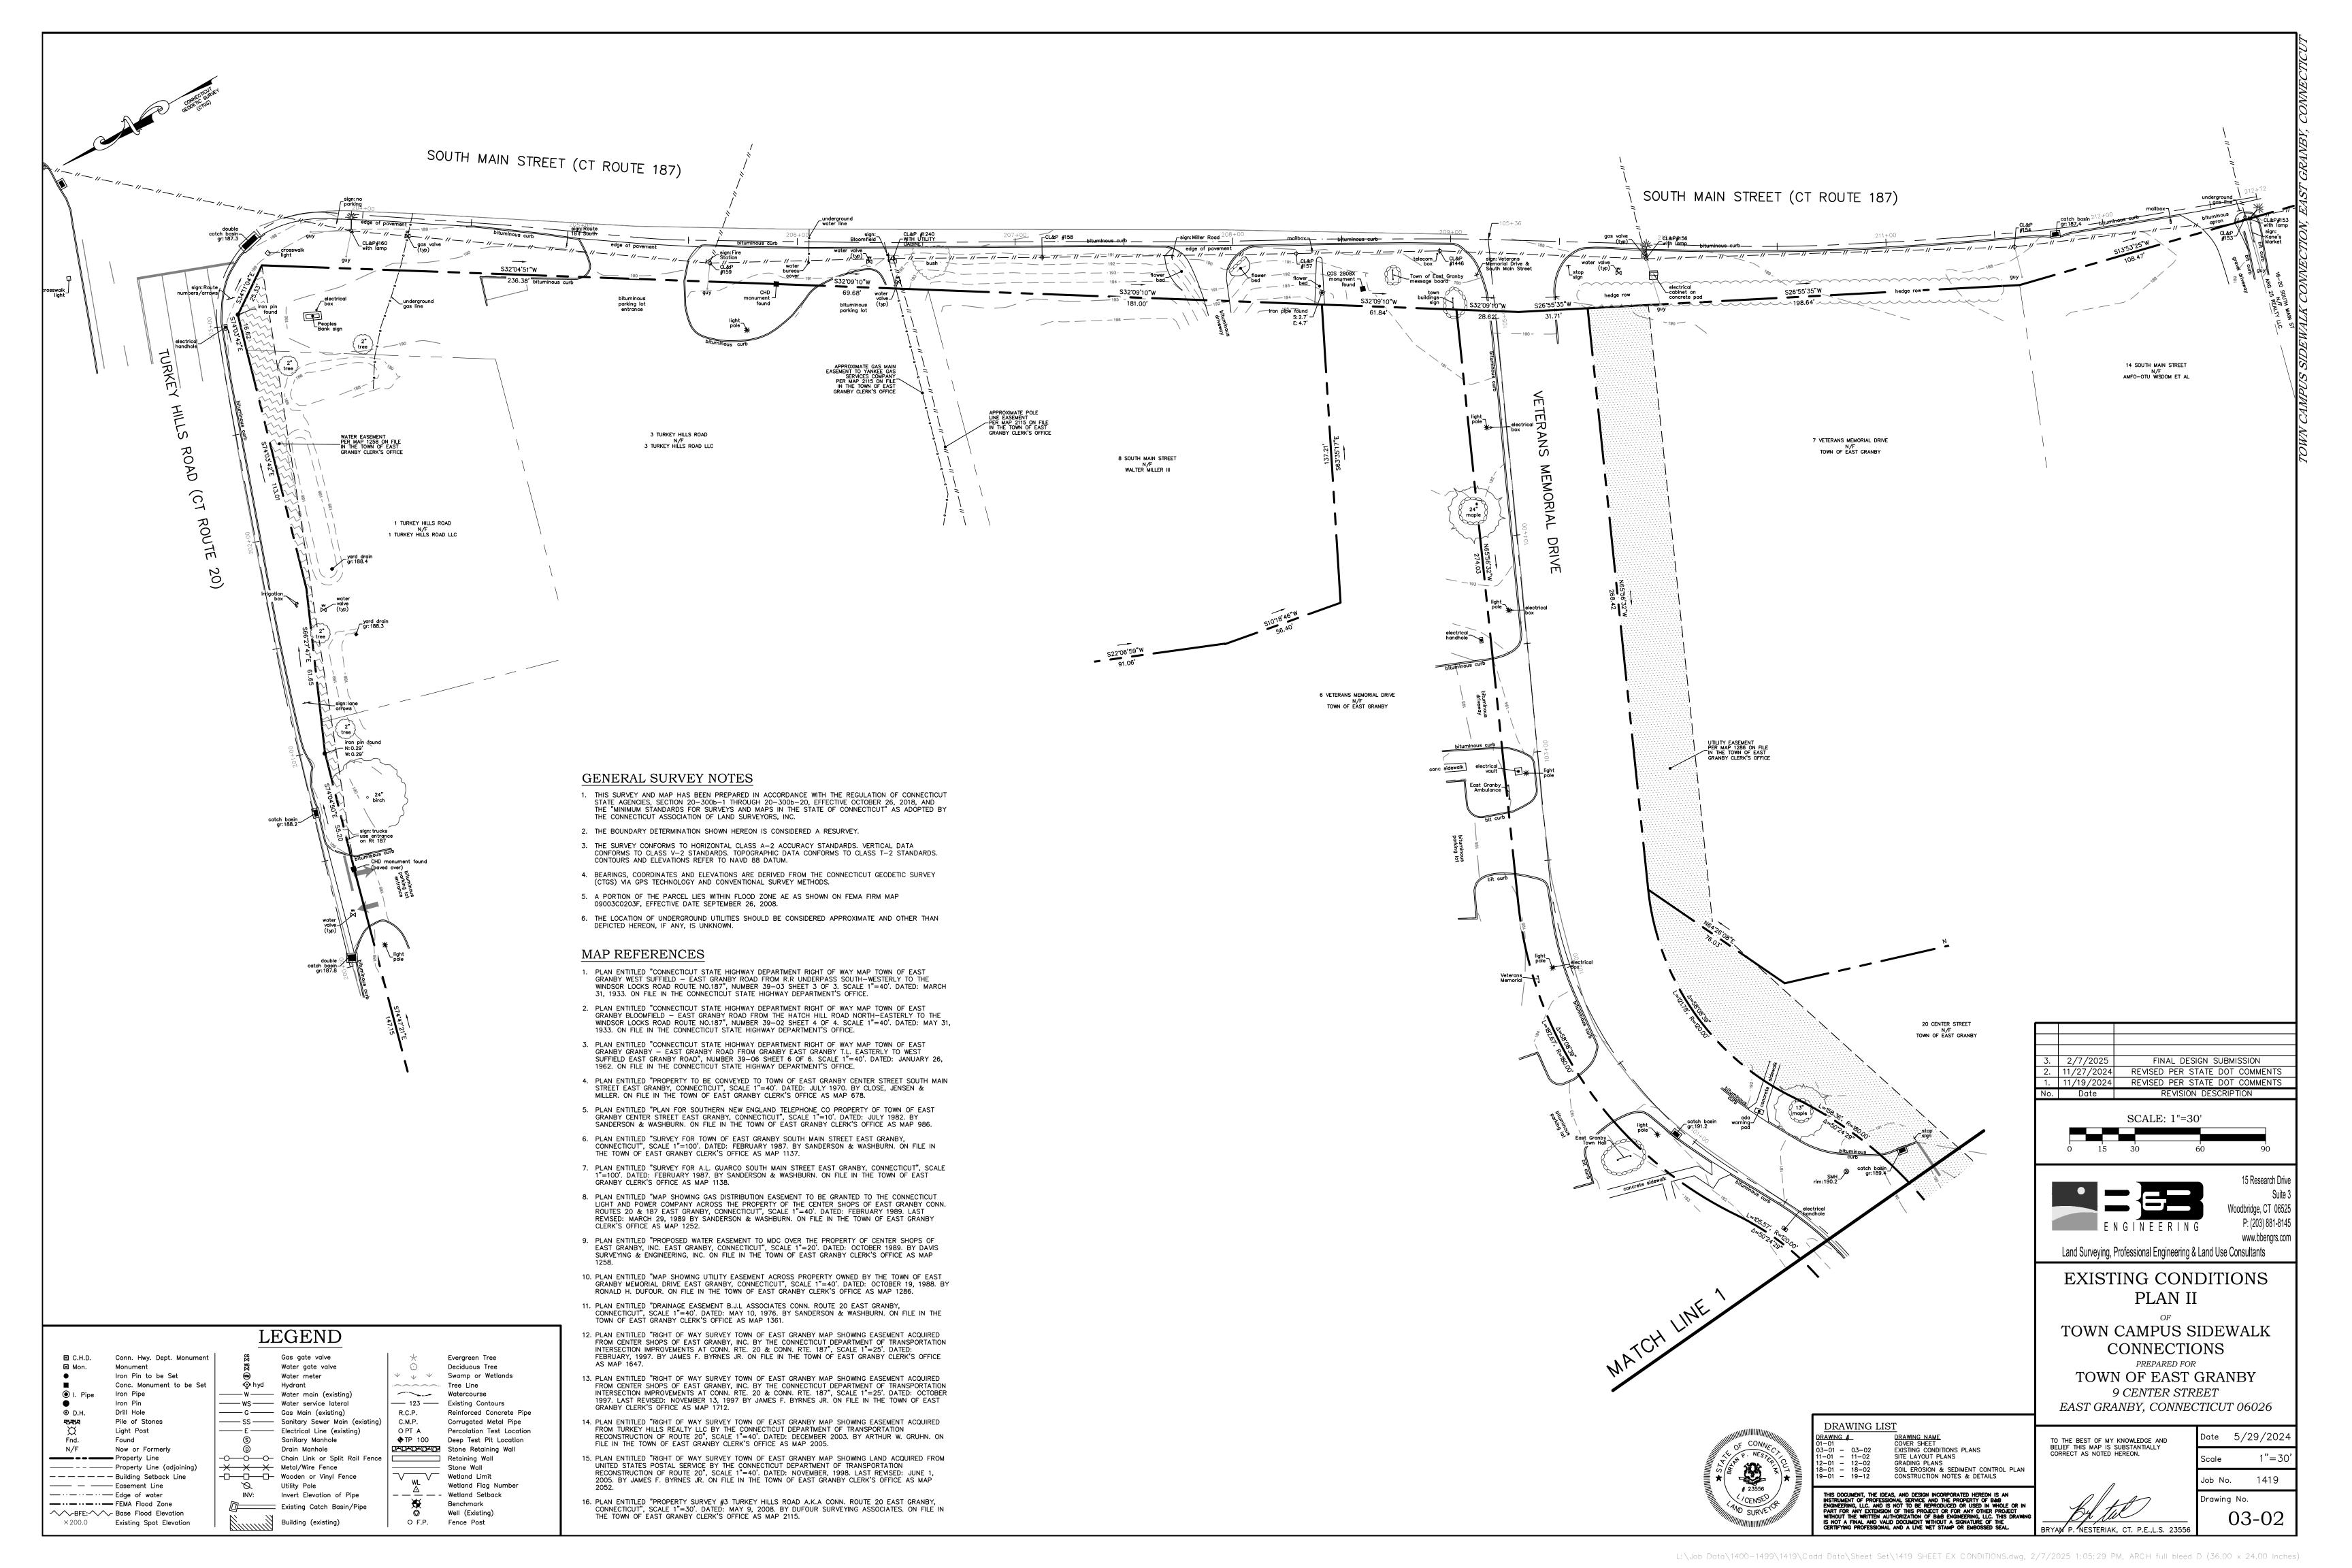


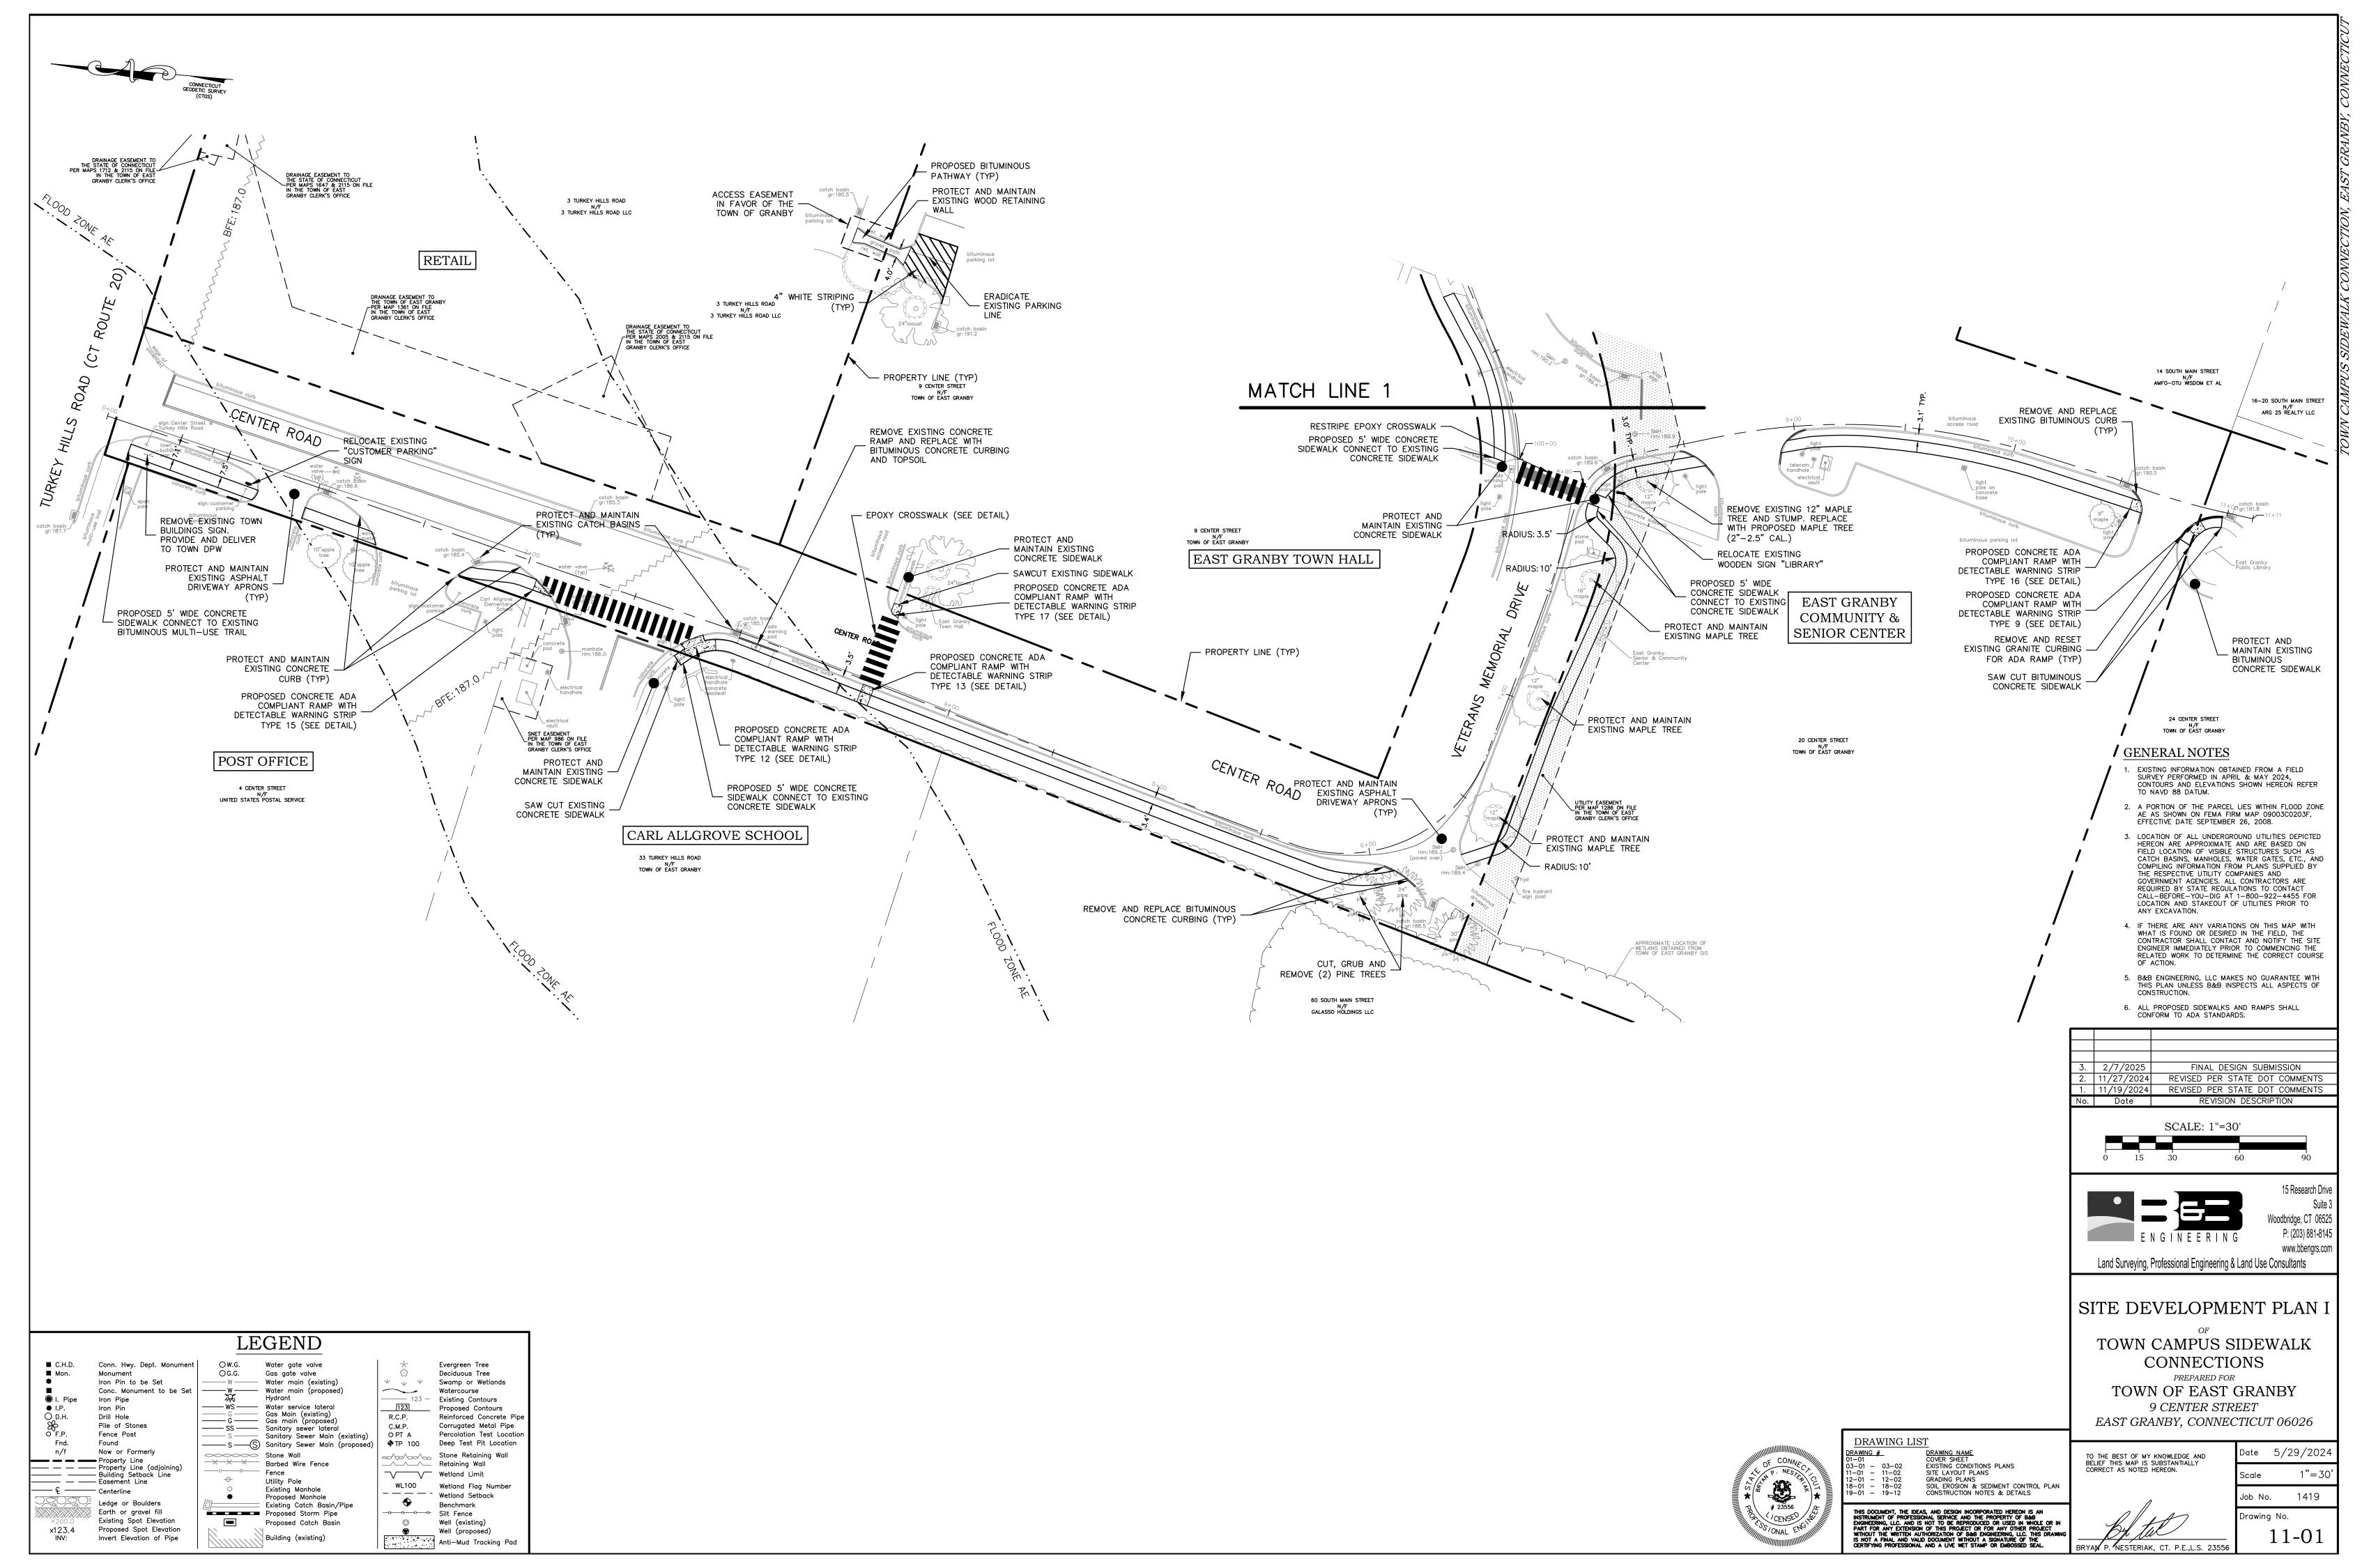
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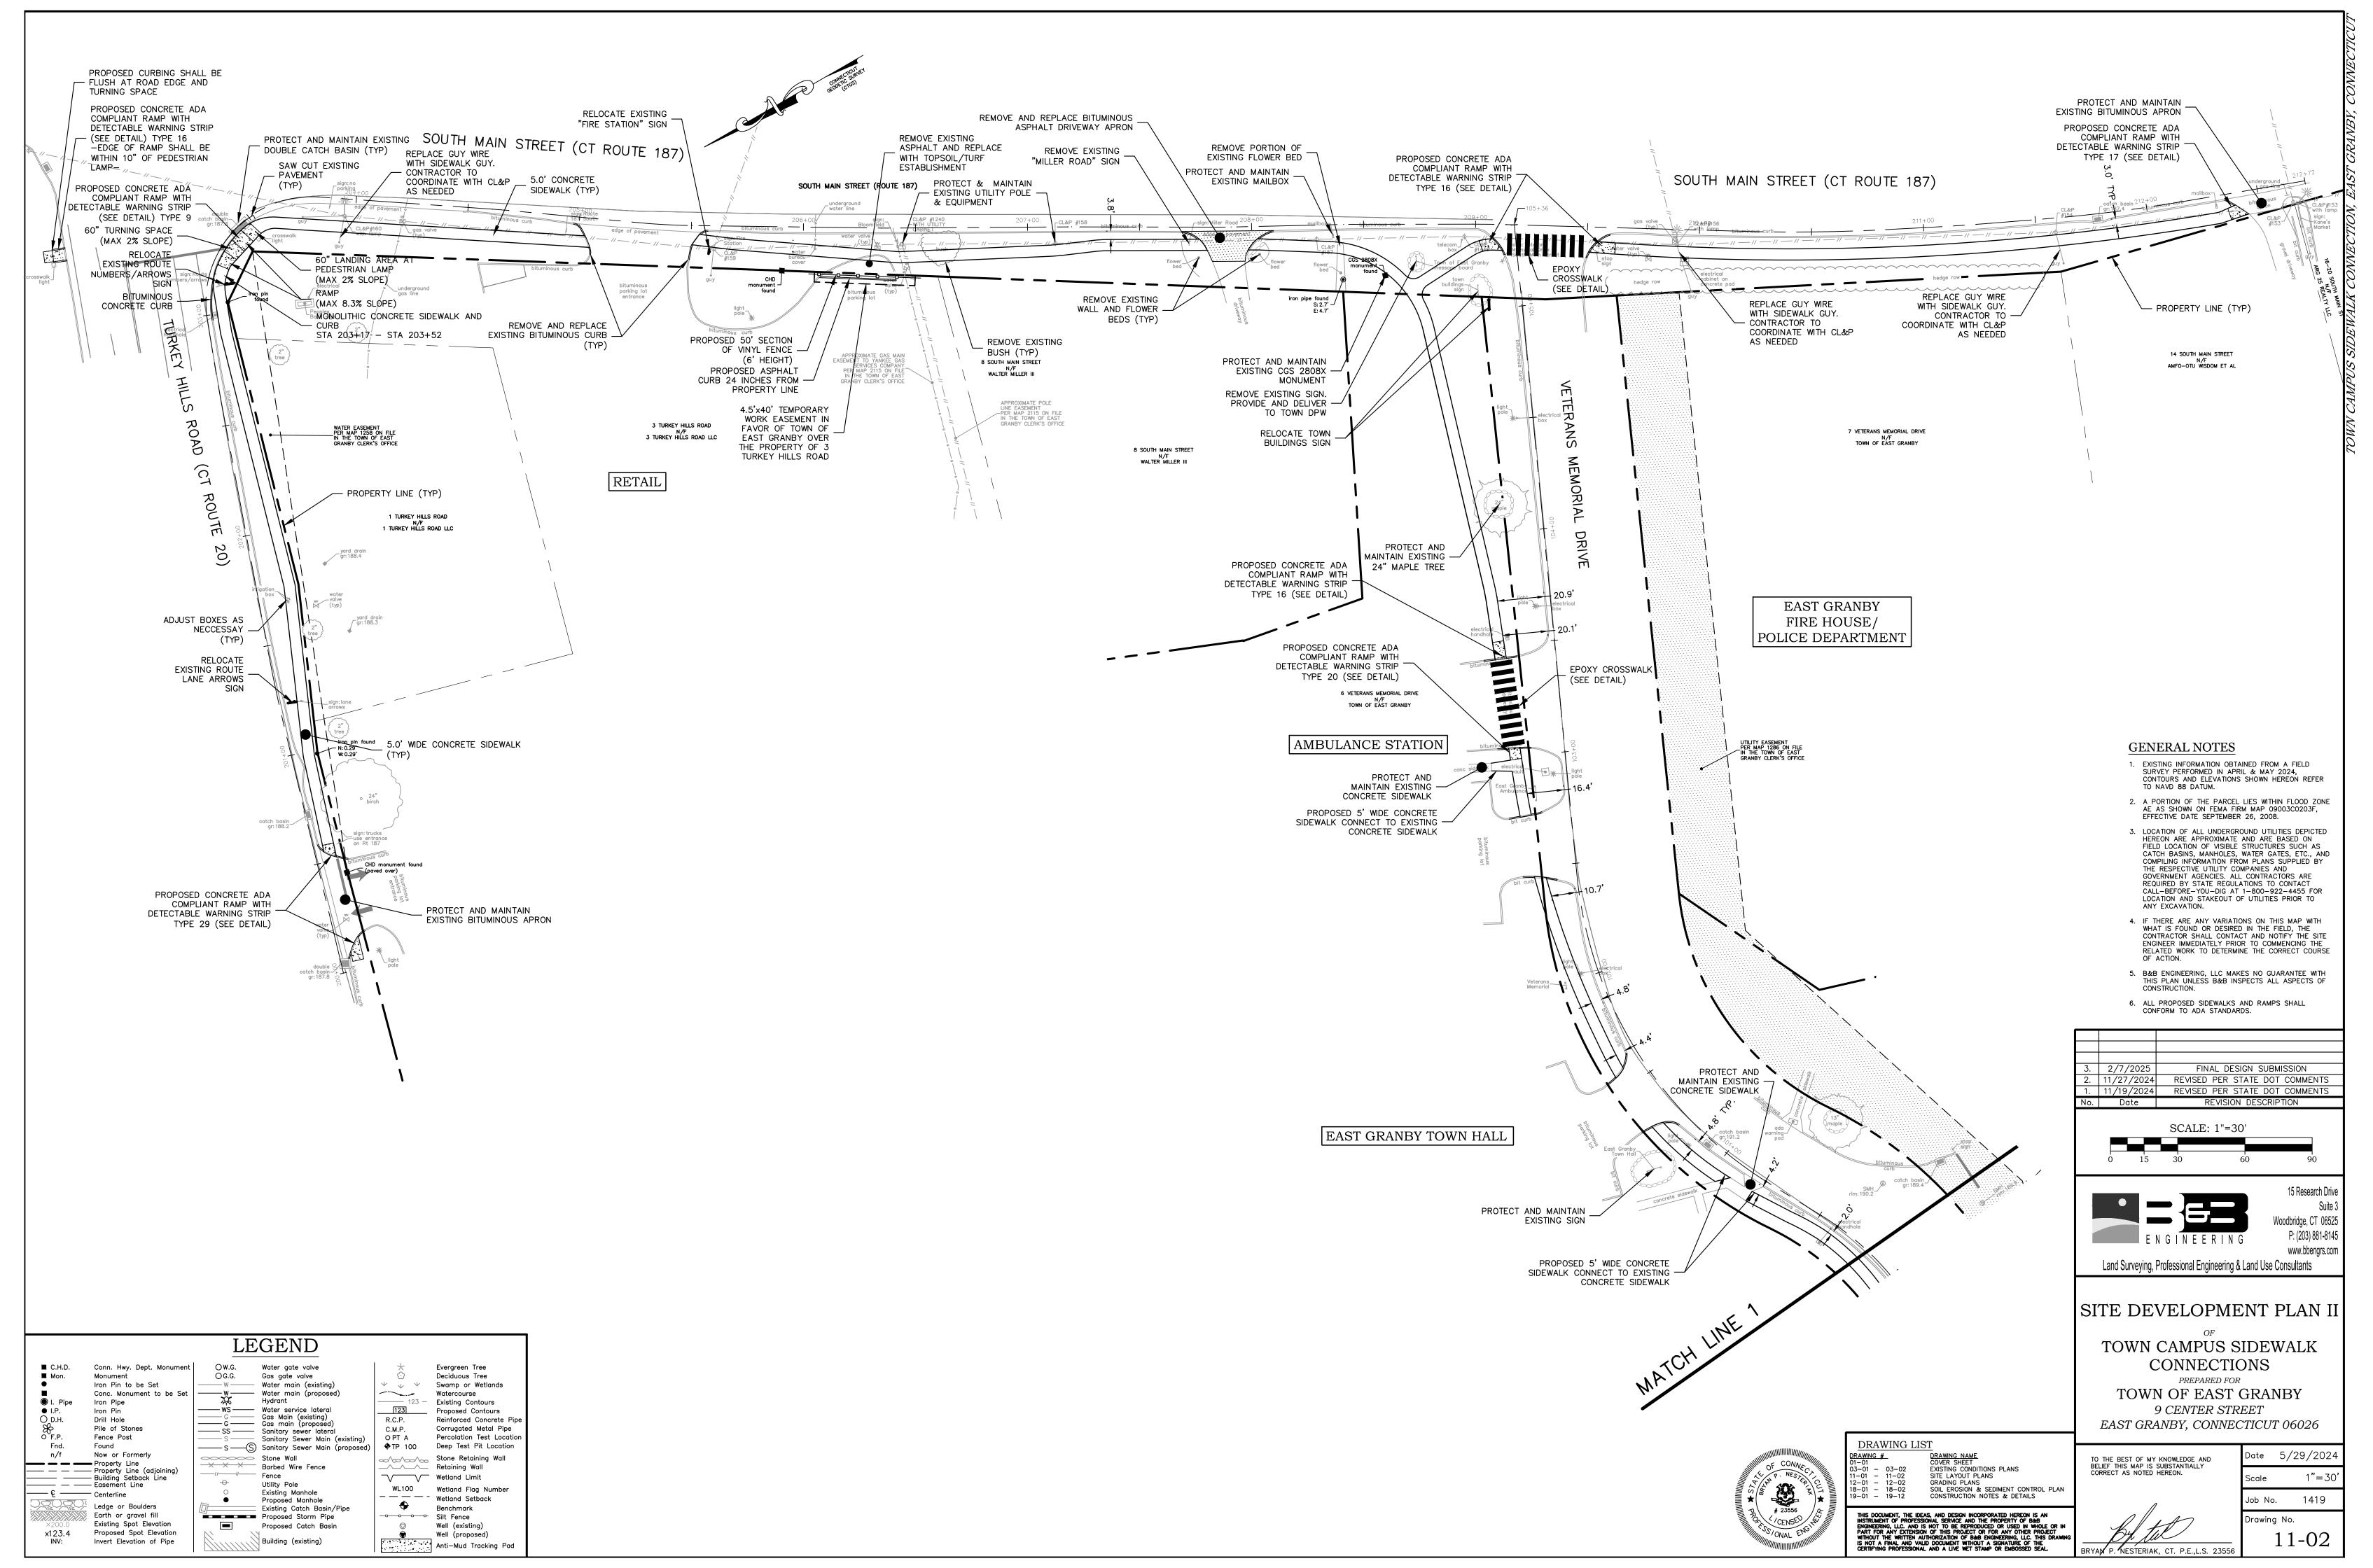
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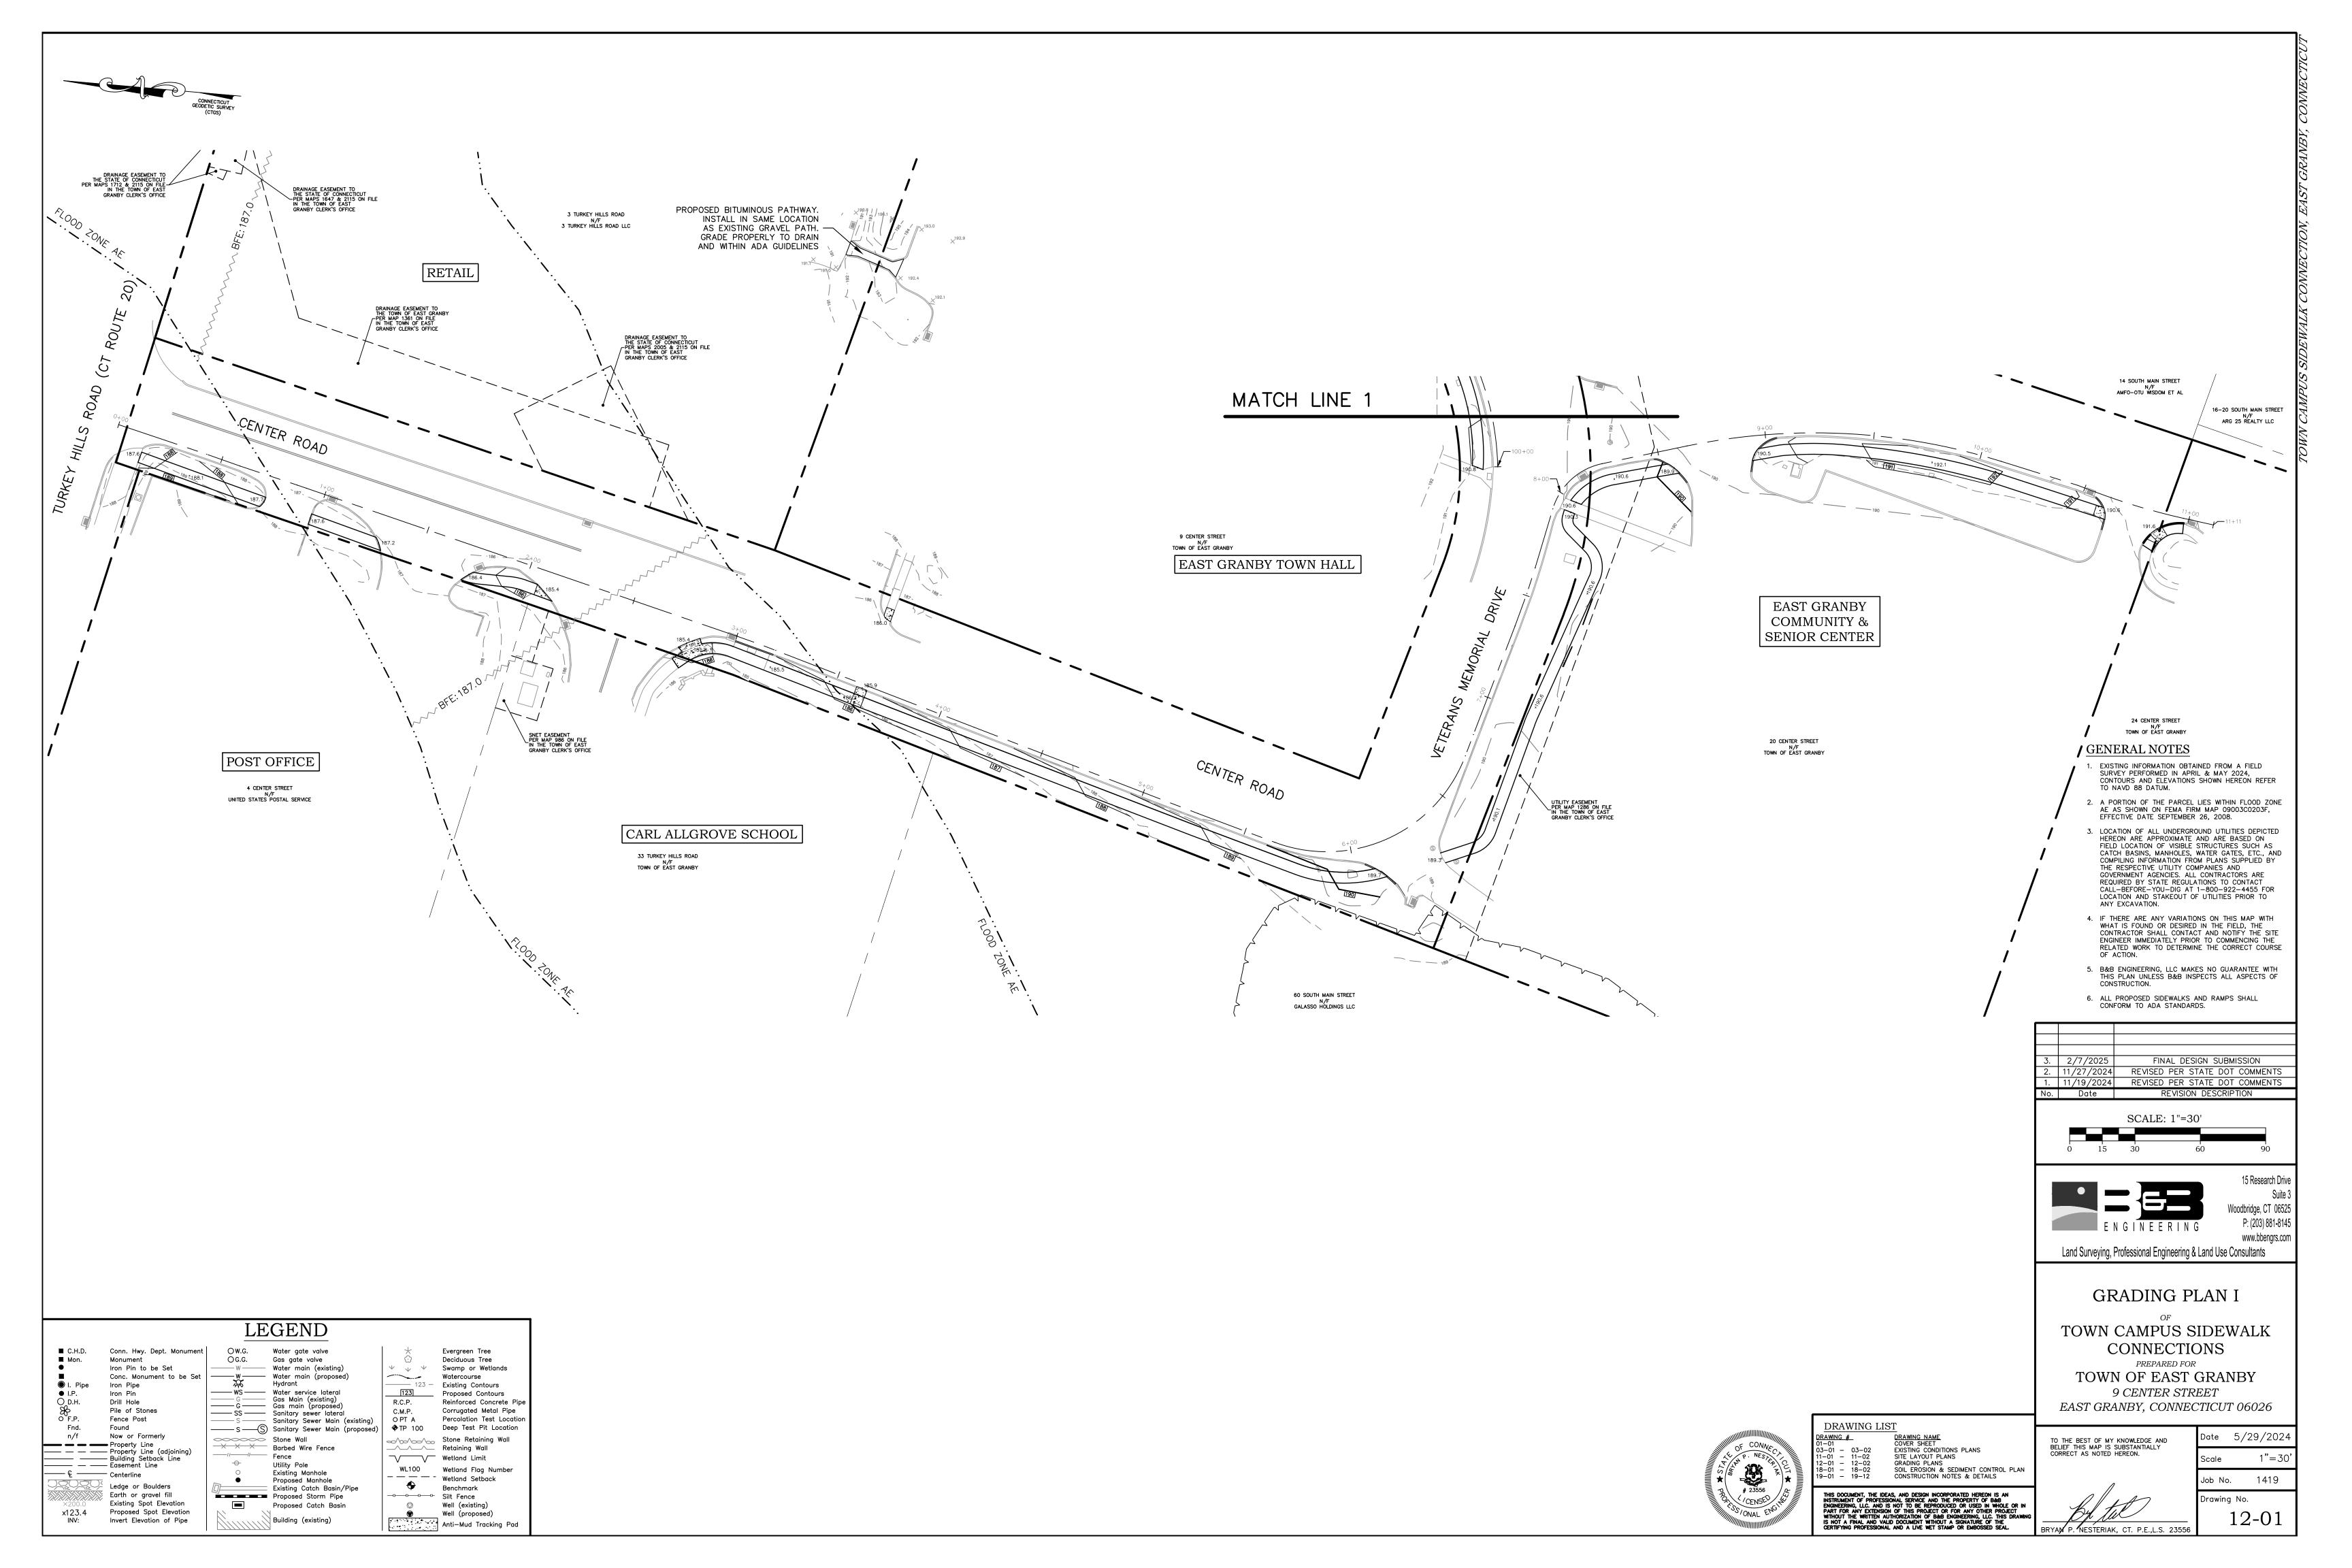
01-01

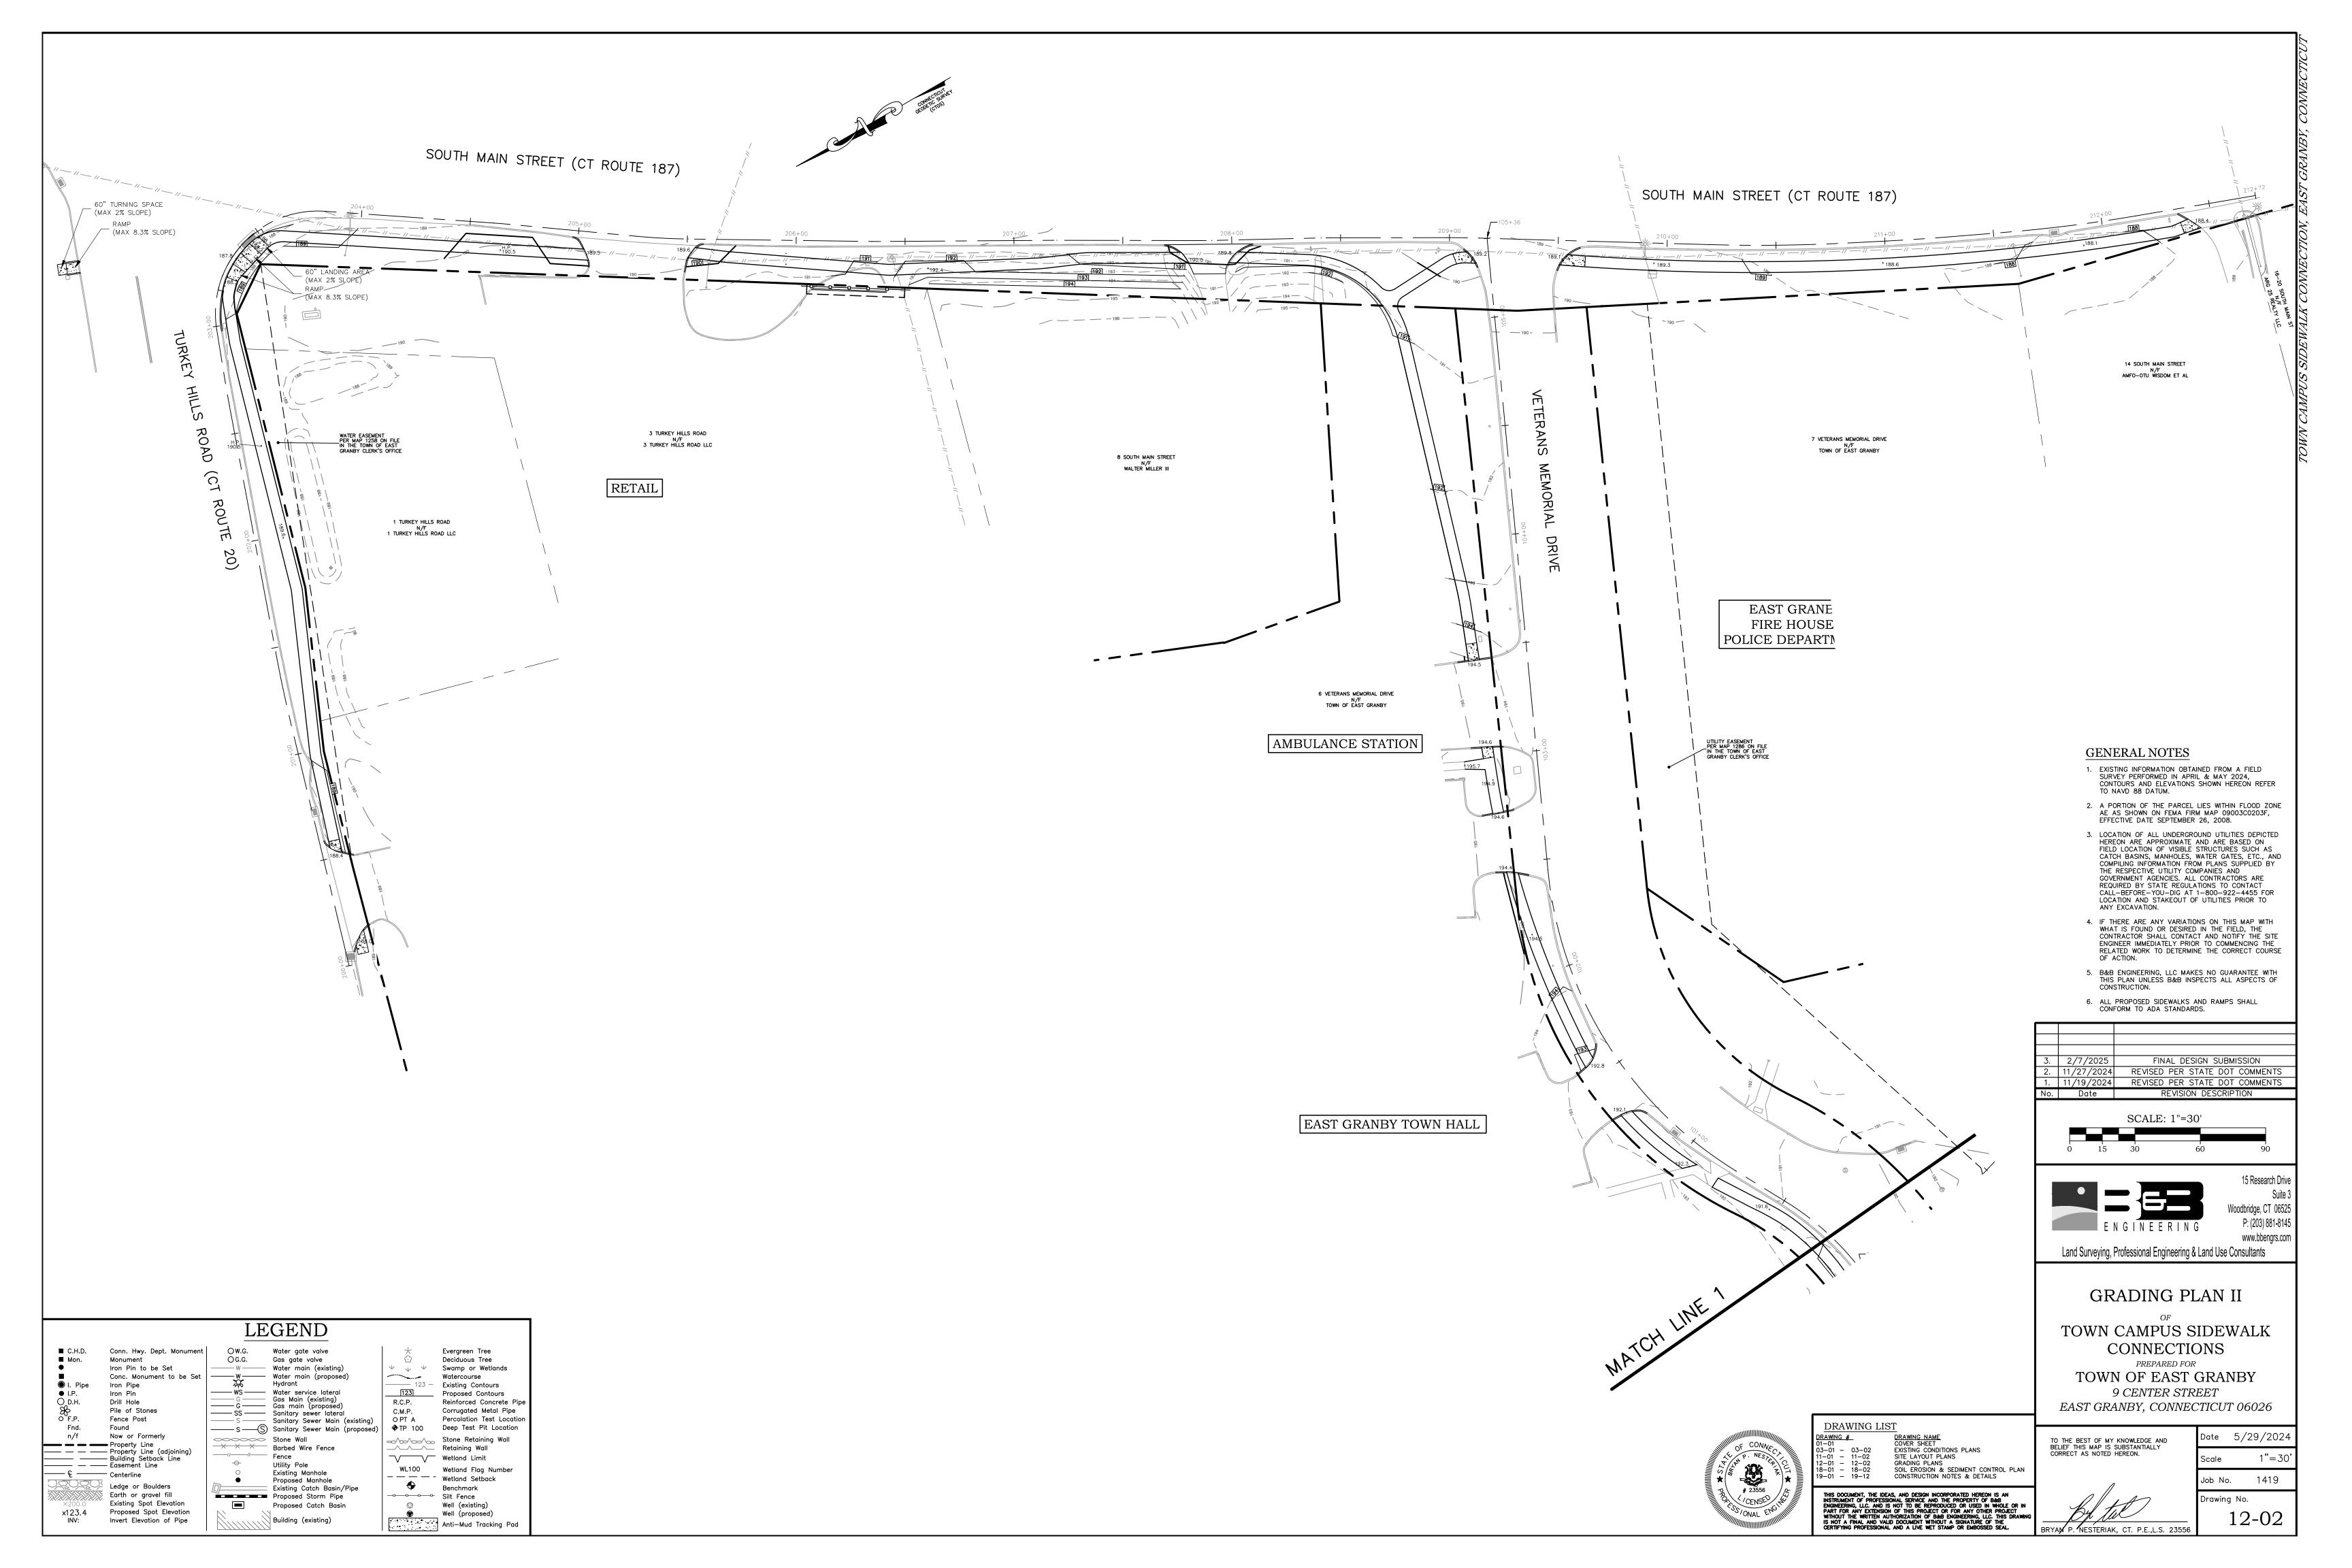


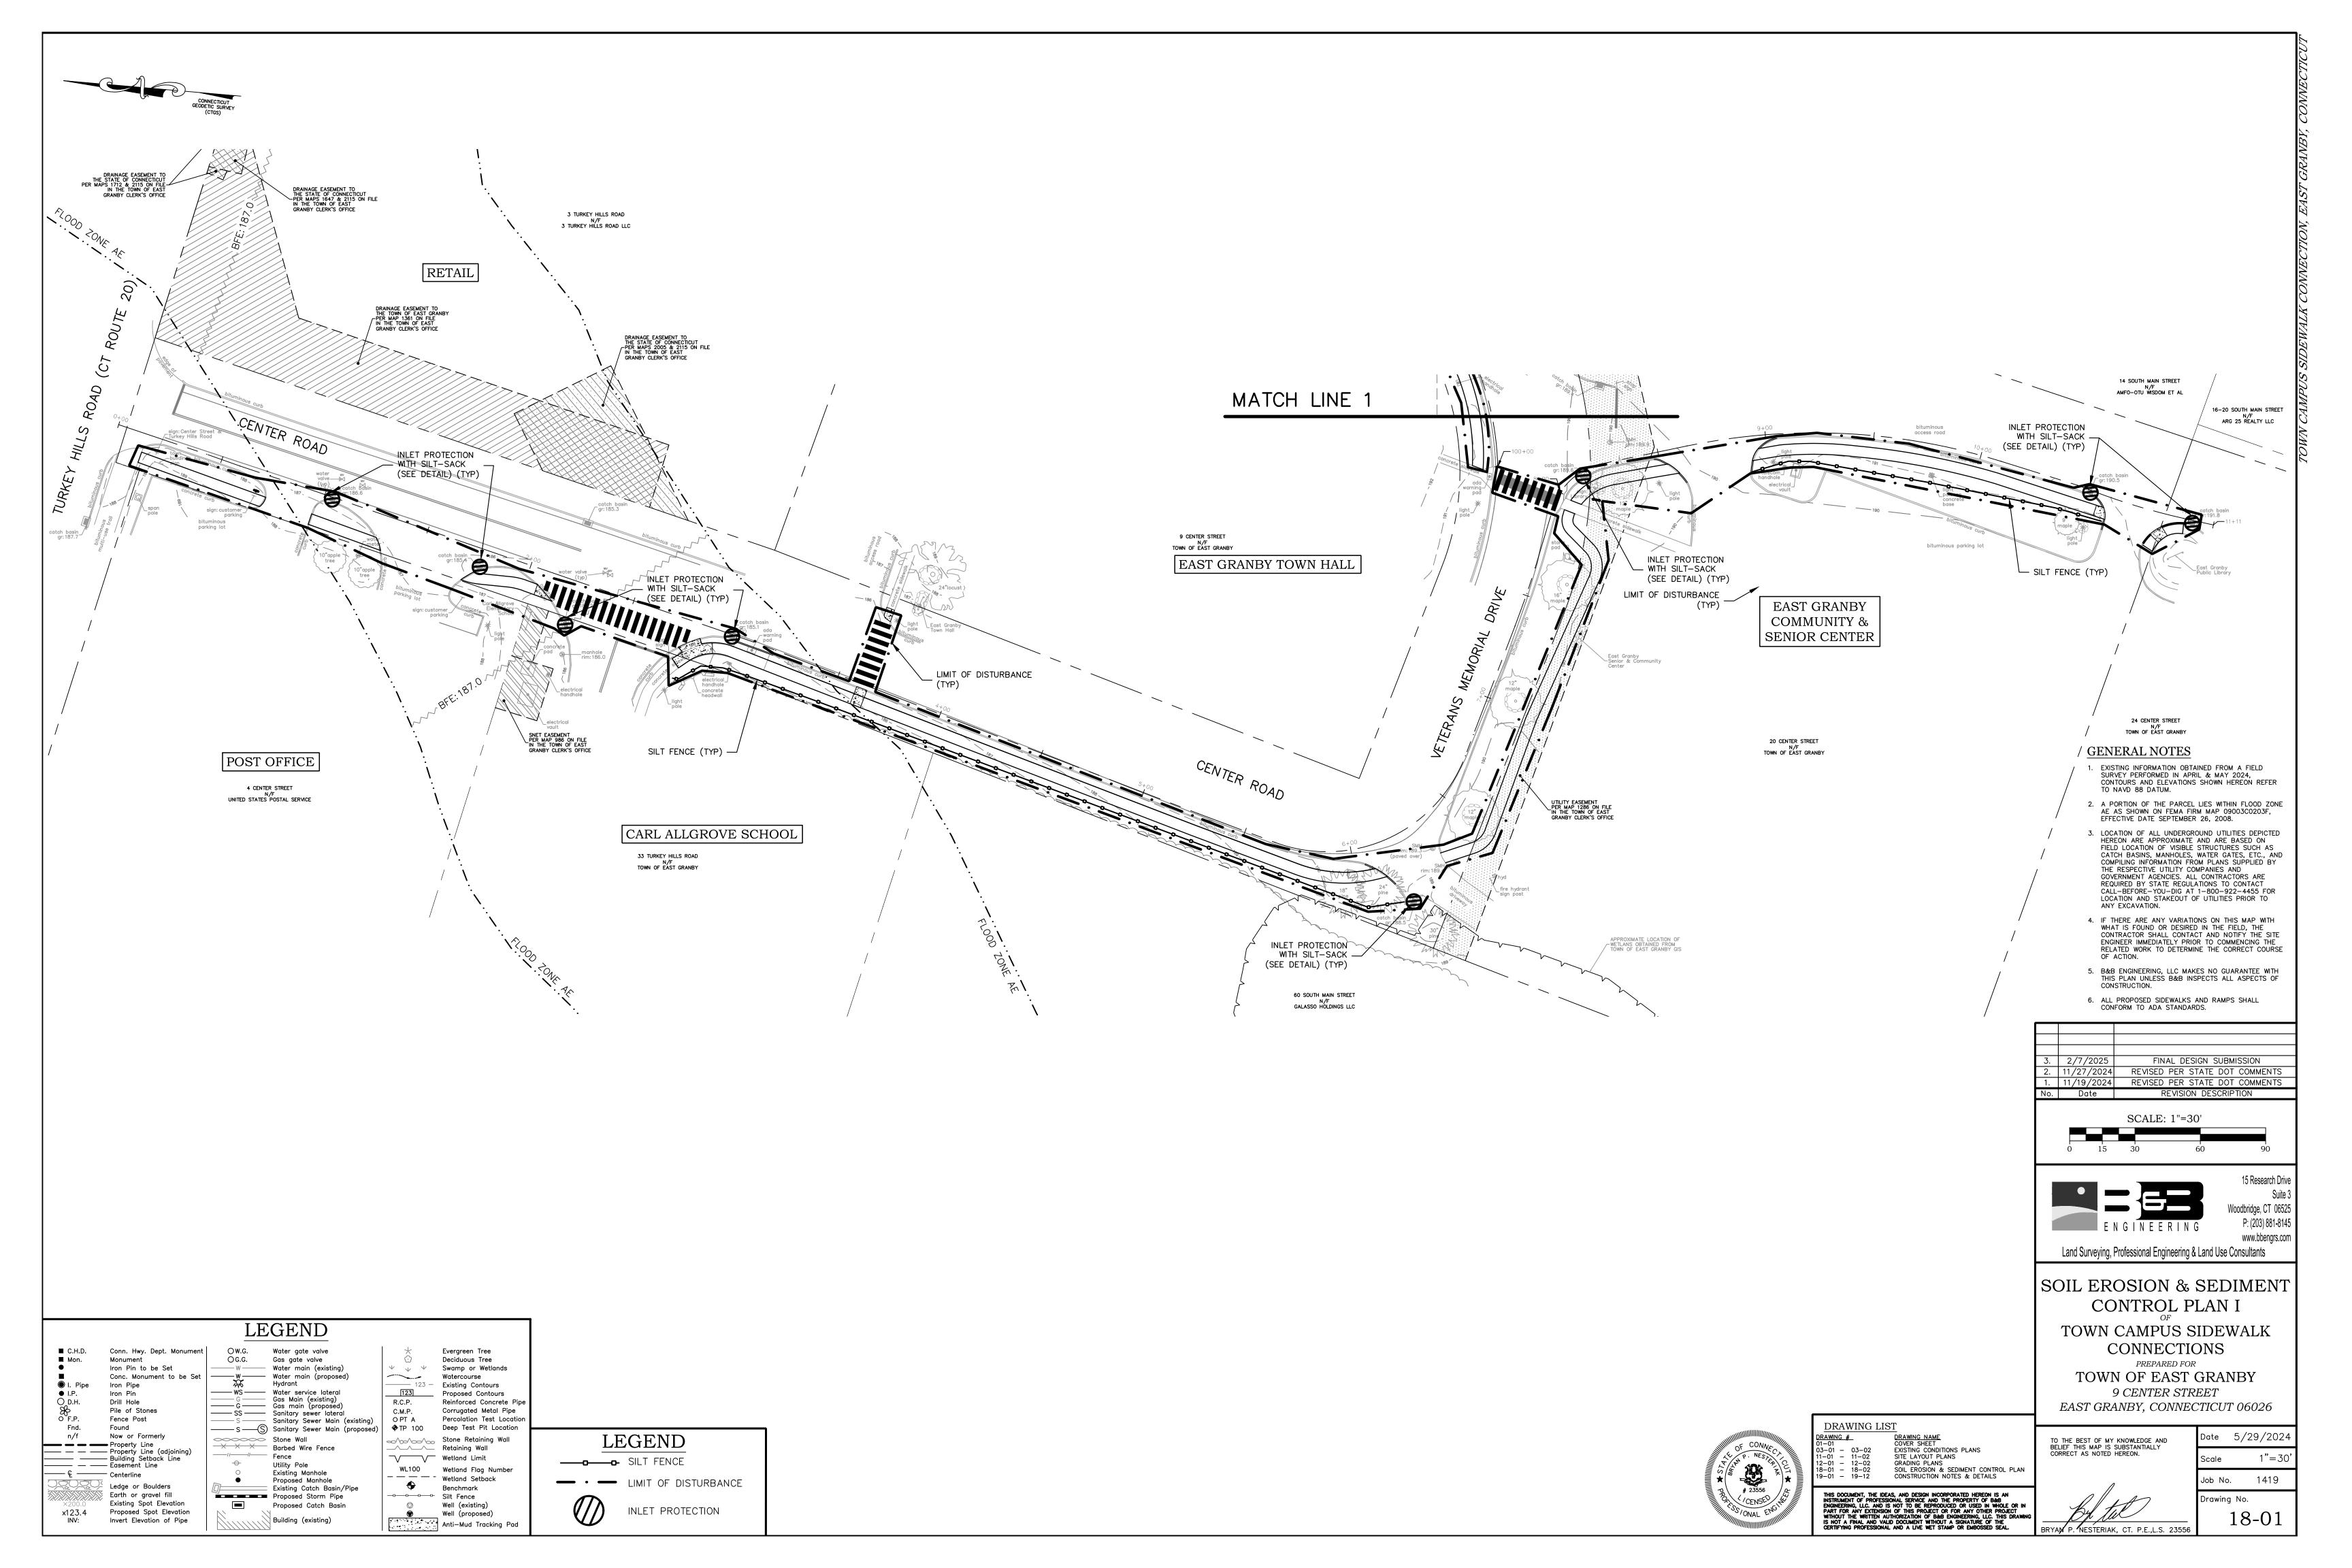


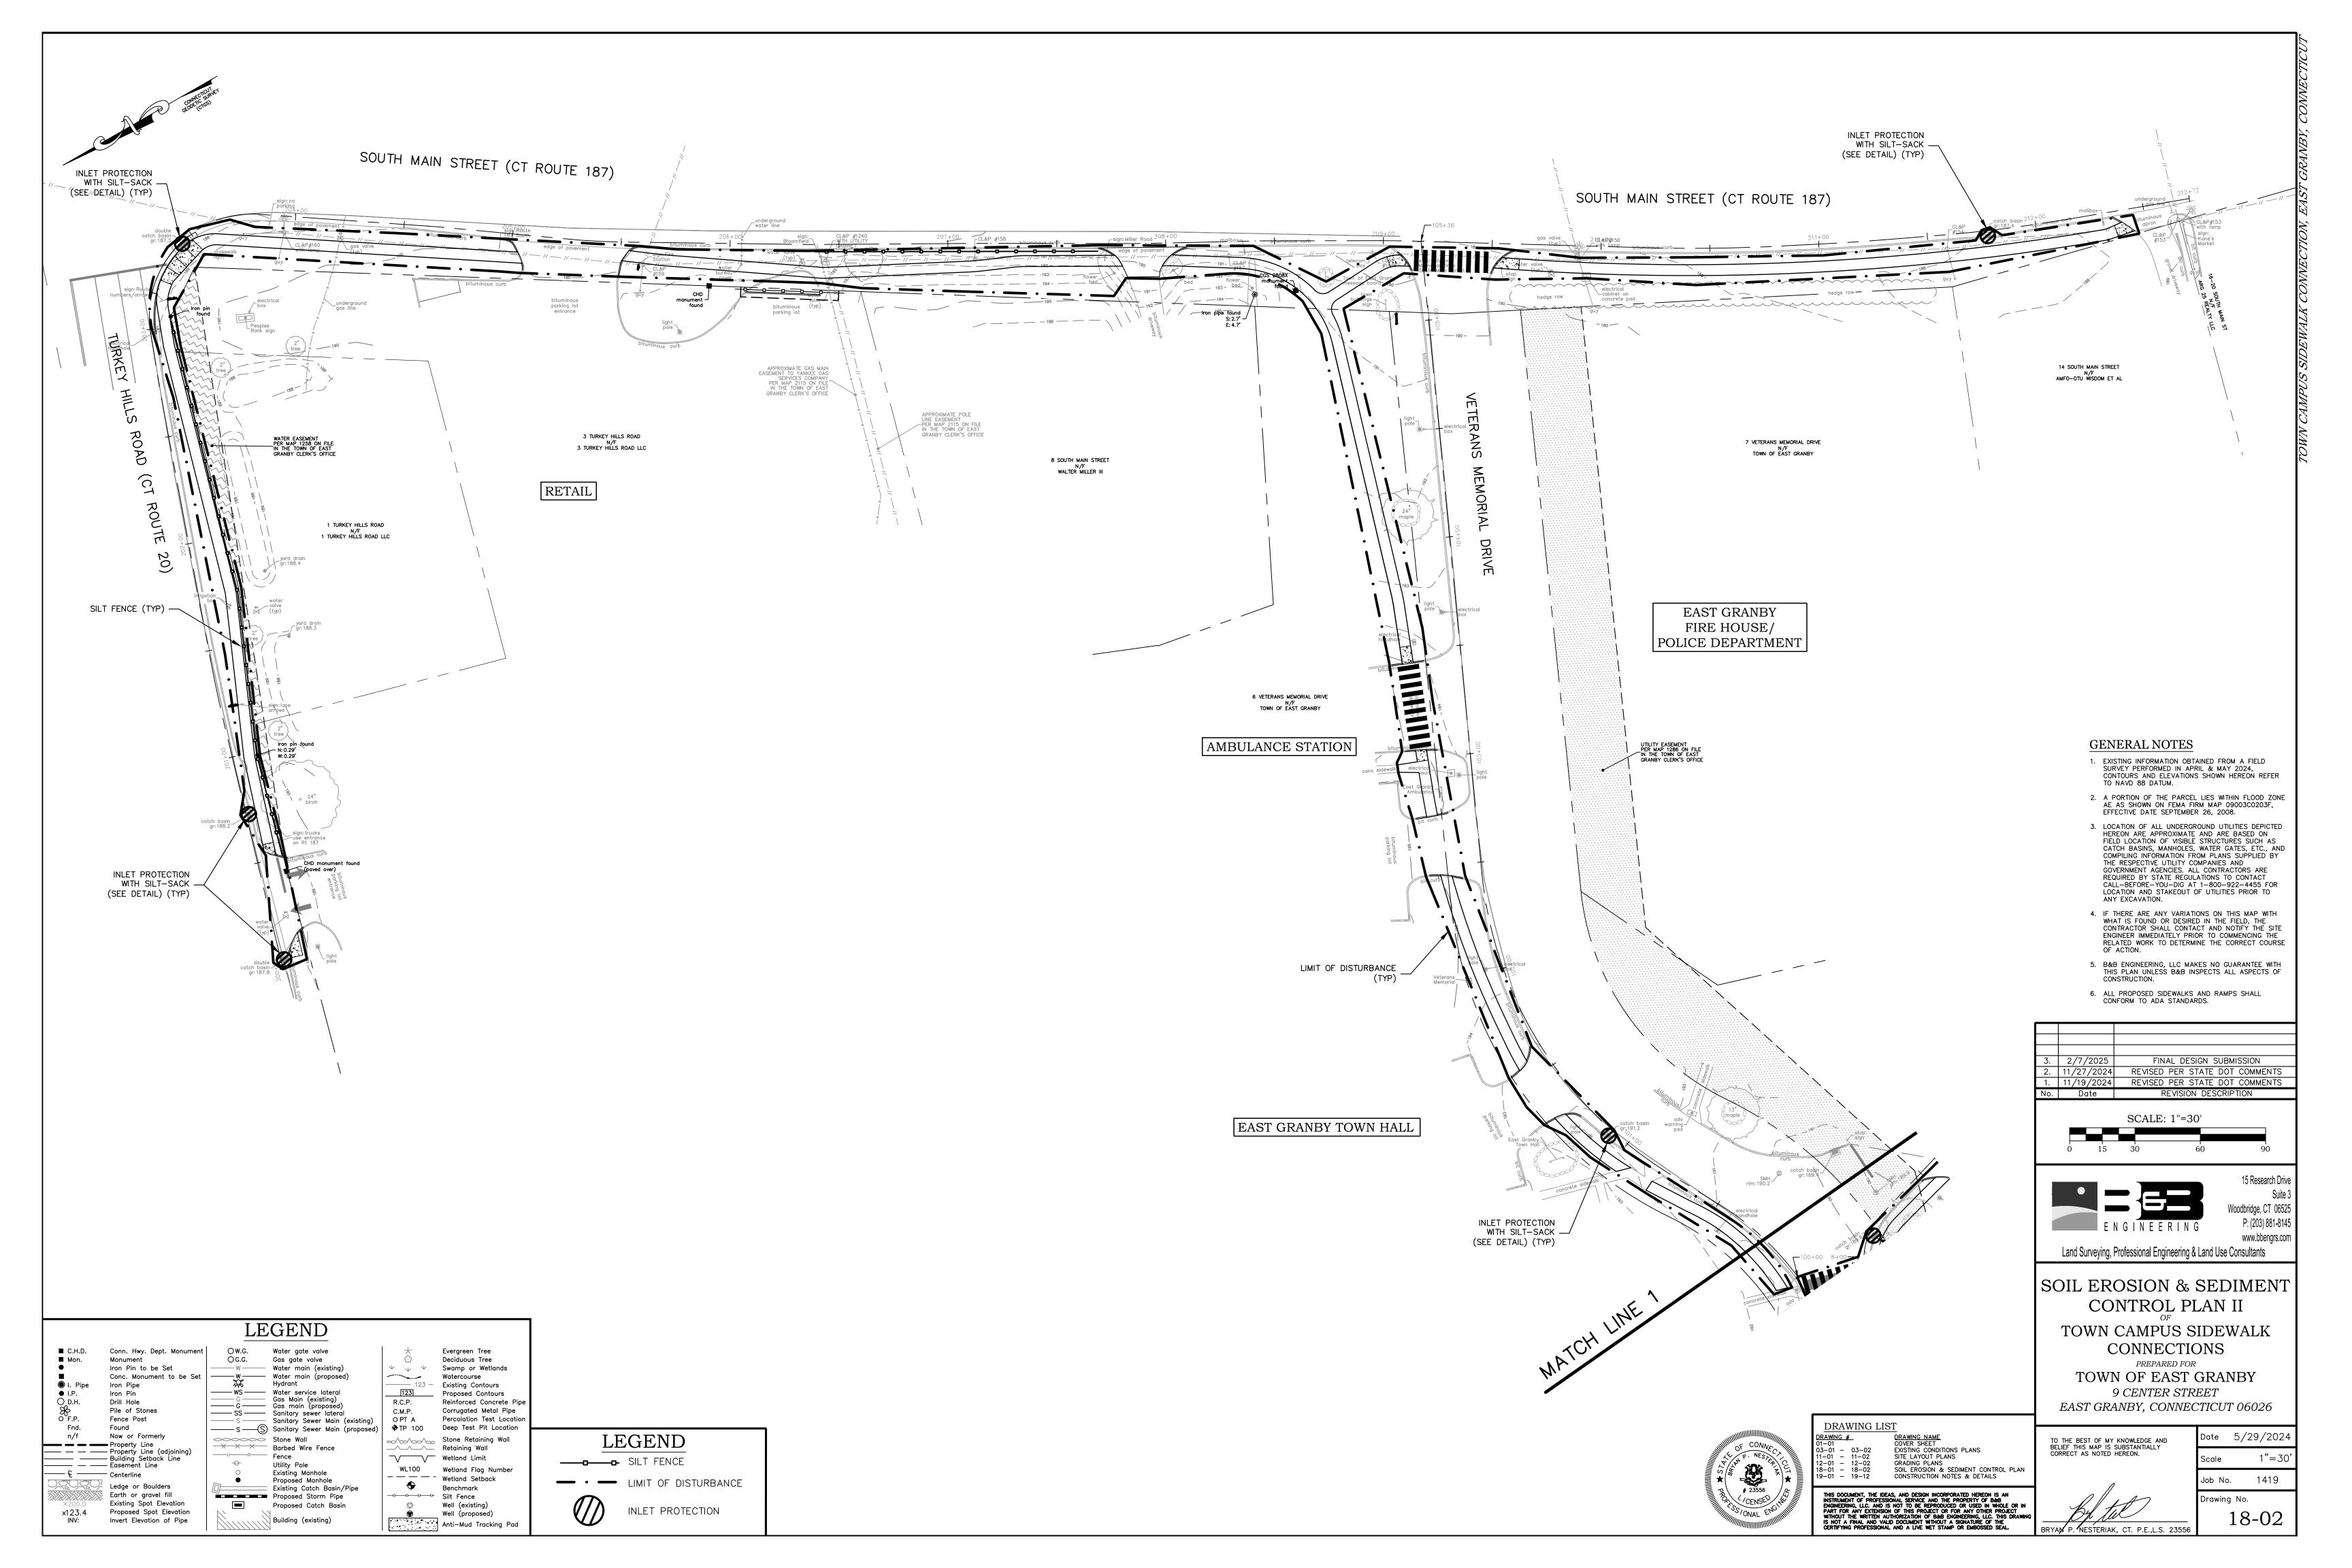












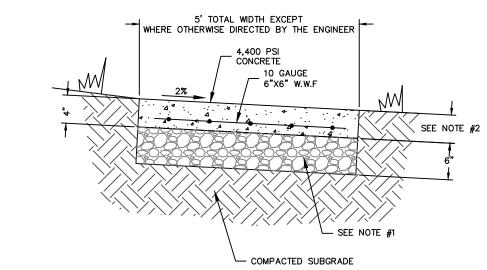
SEDIMENTATION & SOIL EROSION SPECIFICATIONS

- 1. THESE GUIDELINES SHALL APPLY TO ALL WORK CONSISTING OF ANY AND ALL TEMPORARY AND OR PERMANENT MEASURES TO CONTROL WATER POLLUTION AND SOIL EROSION AS MAY BE REQUIRED, DURING THE CONSTRUCTION OF THE PROJECT.
- 2. ALL CONSTRUCTION ACTIVITIES SHALL PROCEED SO THAT POLLUTION OF ANY WETLANDS, WATERCOURSES, WATERBODY, AND OR CONDUIT CARRYING WATER, ETC. DOES NOT OCCUR. THE CONTRACTOR SHALL LIMIT, INSOFAR AS POSSIBLE, THE SURFACE AREA OF EARTH MATERIALS EXPOSED BY CONSTRUCTION METHODS AND IMMEDIATELY PROVIDE PERMANENT AND TEMPORARY POLLUTION CONTROL MEASURES TO PREVENT CONTAMINATION OF ADJACENT WETLANDS, WATERCOURSES AND WATERBODIES, AND TO PREVENT, INSOFAR AS POSSIBLE EROSION ON THE SITE.
- 3. CONSTRUCTION METHODS SHALL BE IN ACCORDANCE WITH THE PROVISIONS SET FORTH IN THE "GUIDELINES FOR SOIL EROSION AND SEDIMENT CONTROL" (2002) BY THE STATE OF CONNECTICUT COUNCIL ON SOIL AND WATER CONSERVATION. IMPLEMENTATION NOTES
- 1. THE EROSION AND SEDIMENTATION CONTROL MEASURES ARE TO BE INSTALLED PRIOR TO CONSTRUCTION WHENEVER POSSIBLE. ALL CONTROL MEASURES ARE TO BE MAINTAINED IN AN EFFECTIVE CONDITION THROUGHOUT THE CONSTRUCTION PERIOD. ADDITIONAL MEASURES ARE TO BE INSTALLED IF NECESSARY OR REQUIRED DURING CONSTRUCTION
- 2. LAND DISTURBANCE SHALL BE KEPT TO A MINIMUM. RESTABLIZATION TO BE SCHEDULED AS SOON AS PRACTICAL.
- 3. POST AND FABRIC SILTATION BARRIERS SHALL BE INSTALLED AT THE TOE OF ALL CRITICAL CUT AND FILL SLOPES. SILT FENCES AND BARRIERS MUST BE CLEANED OR REPLACED
- 4. ALL STORM DRAINAGE OUTLETS MUST BE STABILIZED, AS REQUIRED, BEFORE THE DISCHARGE POINTS BECOME OPERATIONAL.

WHEN SOIL HAS REACHED ONE-THIRD THE HEIGHT OF THE FENCE.

- 5. SEDIMENT TRAPS, IF APPLICABLE, MUST BE CLEANED WHEN CAPACITY HAS BEEN REDUCED BY AN AVERAGE OF 2' OVER ITS TOTAL AREA OR TO 80% OF ITS DESIGN VOLUMES,
- 6. SEDIMENT REMOVED FROM THE CONTROL STRUCTURES SHALL BE DISPOSED OF IN A MANNER CONSISTENT WITH THE INTENT OF THE PLAN AND IN ACCORDANCE WITH LOCAL, STATE, & FEDERAL REGULATIONS
- 7. FILL MATERIAL SHALL BE FREE FROM DEBRIS PERISHABLE OR COMBUSTIBLE MATERIAL AND FROZEN OR WET EARTH OR STONES LARGER THAN 6 INCHES IN MAXIMUM DIMENSION. FILL SHALL BE PLACED IN MAXIMUM 12 INCH LOOSE LIFTS AND COMPACTED TO WITHIN 90% OF THE MODIFIED PROCTOR TEST RESULT.
- 8. PAVEMENT BASE COURSE MUST BE PLACED IN ALL PROPOSED PAVEMENT AREAS UPON COMPLETION OF FINE GRADING.
- 9. PERMANENT LANDSCAPED AREAS SHALL BE SEEDED OR SODDED ON ALL EXPOSED AREAS IMMEDIATELY AFTER FINAL GRADING. MULCH AS NECESSARY FOR SEED PROTECTION AND ESTABLISHMENT. LIME AND FERTILIZE PRIOR TO PERMANENT SEEDING.
- 9.1. TOPSOIL PREPARATION: 9.1.1. TOPSOIL SHOULD BE A MINIMUM OF FOUR INCHES DEEP (COMPACTED) BEFORE
- 9.1.2. HAVE TOPSOIL TESTED FOR PH, ADD LIME AS NECESSARY TO ACHIEVE PH OF 6.5. APPLY FERTILIZER AT A RATE OF 300 POUNDS PER ACRE OR SEVEN POUNDS PER 4.000 SQUARE FEET USING 10-20-10 OR EQUIVALENT. IN ADDITION, 300 POUNDS 38-0-0 PER ACRE OF SLOW RELEASE NITROGEN MAY BE USED IN LIEU
- OF TOP DRESSING. 9.1.3. WORK LIME AND FERTILIZER INTO SOIL AS NEARLY AS PRACTICAL TO A DEPTH OF FOUR INCHES WITH A DISC, SPRINGTOOTH HARROW OR OTHER SUITABLE EQUIPMENT. THE FINAL HARROWING OR DISCING OPERATION SHOULD BE ON THE GENERAL CONTOUR. CONTINUE ALL CLAY OR SILTY SOIL AND COARSE SANDS SHOULD BE ROLLED TO FIRM THE SEED BED WHEREVER FEASIBLE.
- 9.1.4. REMOVE FROM THE SURFACE ALL STONES ONE INCH OR LARGER IN ANY DIMENSION, REMOVE ALL OTHER DEBRIS, SUCH AS WIRE, CABLE, TREE ROOTS, PIECES OF CONCRETE, CLODS, LUMP, OR OTHER UNSUITABLE MATERIAL.
- 9.1.5. INSPECT SEED BED JUST BEFORE SEEDING. IF TRAFFIC HAS LEFT SOIL COMPACT, THE AREA MUST BE RE-TILLED AND COMPACTED AS ABOVE.
- 9.2. SEED MIXTURE (APPLY AT A RATE OF 200 POUNDS/ACRE): 9.2.1. 10% KENTUCKY BLUEGRASS - BARON MIX
- 9.2.2. 20% PERENNIAL RYEGRASS 9.2.3. 70% TURF TYPE TALL FESCUE
- 10. THE CONTRACTOR/OWNER IS RESPONSIBLE FOR ALL PAVED ROADWAYS ON AND OFF SITE AND MUST ENSURE THE SITE IS FREE OF SITE GENERATED SEDIMENT AT ALL TIMES. DUST SHALL BE CONTROLLED BY SPRINKLING OR ANOTHER APPROVED METHOD.
- 11. ALL EROSION AND SEDIMENT CONTROL DEVICES MUST BE INSPECTED ON A DAILY BASIS
- 12. WHERE DEWATERING IS NECESSARY, THERE SHALL NOT BE A DISCHARGE DIRECTLY INTO WETLANDS OR WATERCOURSES. PROPER METHODS AND DEVICES SHALL BE UTILIZED TO THE EXTENT PERMITTED BY LAW, SUCH AS PUMPING WATER INTO A TEMPORARY SEDIMENTATION STRUCTURE OR BOWL, PROVIDING SURGE PROTECTION AT THE INLET AND THE OUTLET OF PUMPS, OR FLOATING THE INTAKE OF THE PUMP, OR OTHER METHODS TO MINIMIZE AND RETAIN THE SUSPENDED SOLIDS. IF PUMPING OPERATION CAUSES TURBIDITY PROBLEMS, THE OPERATION SHALL CEASE UNTIL FEASIBLE MEANS OF CONTROLLING TURBIDITY ARE DETERMINED AND IMPLEMENTED.
- 13. THE RESPONSIBILITY FOR: IMPLEMENTING THE EROSION AND SEDIMENT CONTROL PLAN, INFORMING ALL CONCERNED OF THE REQUIREMENT OF THE PLAN: NOTIFYING THE PLANNING AND ZONING COMMISSION, ITS DESIGNATED REPRESENTATIVE OF ANY TRANSFER OF RESPONSIBILITY AND SEEING THAT A COPY OF THE PLAN IS RECEIVED BY ANY SUCCESSOR IN INTEREST TO THE TITLE OF THE LAND OR ANY PORTION THEREOF IS ASSIGNED TO THE OWNER OF RECORD.
- 14. ANY CONVEYANCE OF THIS PROJECT PRIOR TO ITS COMPLETION, WILL TRANSFER FULL RESPONSIBILITY FOR COMPLIANCE WITH THE CERTIFIED PLAN TO ANY SUBSEQUENT

CONCRETE SIDEWALK



GRANULAR FILL OR RECLAIMED MISCELLANEOUS AGGREGATE BASE SHALL BE PLACED IN LAYERS NOT TO EXCEED 6 INCHES DEEP AND TO SUCH A DEPTH THAT AFTER COMPACTION IT SHALL BE AT THE SPECIFIED DEPTH BELOW THE FINISHED GRADE OF THE WALK. THE BASE SHALL BE WETTED AND ROLLED OR TAMPED AFTER SPREADING OF EACH LAYER.

CONCRETE SIDEWALK THICKNESS SHALL BE AT LEAST 5" THICK. AREAS OF DRIVEWAY APRONS SHALL BE AT LEAST 8" THICK. SIDEWALK AND CURBING SHALL BE REINFORCED WITH 10 GAUGE 6"X6"W.W.F 2" OFF THE SUBBASE. A #4 REBAR SHALL BE PROVIDED IN

4400 P.S.I. AND 5" ENTRAINED AIR. EXPANSION AND CONTRACTION JOINTS SHALL BE PROVIDED IN ACCORDANCE WITH THE SPECIFICATIONS OR AS OTHERWISE DIRECTED BY THE ENGINEER. AT A MINIMUM A CONTRACTION JOINT SHALL BE PLACED AT 5' INTERVALS WITH AN EXPANSION JOINT AT 20'

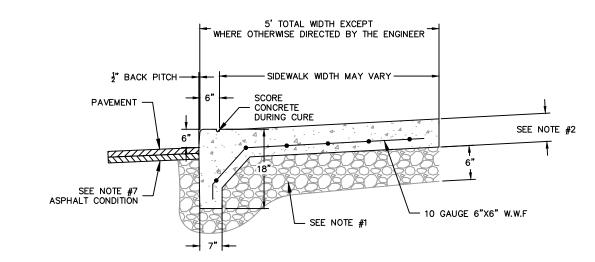
THE TOP-OUTER CORNER OF THE CURB. CONCRETE SHALL BE CLASS "C" HAVING A MINIMUM 28 DAY COMPRESSIVE STRENGTH OF

- THE TOTAL WIDTH OF CONCRETE CURBING AND SIDEWALK SHALL NOT BE LESS THAN 5'0" AT A \$\frac{1}{4}" PER FOOT CROSS PITCH, EXCEPT WHERE OTHERWISE DIRECTED BY THE TOWN ENGINEER.
- CURBING EXTENDING ACROSS DRIVEWAYS SHALL PROVIDE A 2" REVEAL AT THE GUTTER LINE. THE SIDEWALK PANELS SHALL BE RAMPED AT DRIVEWAY CROSSINGS IN ACCORDANCE TO A.D.A. SPECIFICATIONS FOR HANDICAP ACCESS. AT NO POINT SHALL THE PITCH OF THE
- WHERE ADJOINING BITUMINOUS CONCRETE DRIVEWAY OR ROADWAY PAVEMENT IS DAMAGED OR REMOVED, THE LIMITS OF DISTURBANCE SHALL BE DELINEATED WITH A CLEAN VERTICAL CUT 24" FROM GUTTER LINE OF ROAD AND THE PAVEMENT RESTORED WITH BITUMINOUS CONCRETE AS SPECIFIED IN THE PROJECT PLANS OR SPECIFICATIONS. RESTORATION SHALL BE TO THE FULL PRIOR PAVEMENT DEPTH,

FINISHED CONCRETE EXCEED 1:12.

- BUT SHALL NOT BE LESS THAN 3" (11 + 12") FOR ROADWAYS AND 2" FOR DRIVEWAYS. IN ORDER TO ACCOMMODATE THE INSTALLATION OF EXISTING OR PROPOSED SIGNAGE, A 4" DIAMETER PVC POST SLEEVE SHALL BE PLACED WITHIN THE SIDEWALK. THE TOP OF THE SLEEVE SHALL BE SET FLUSH WITH THE SURFACE OF THE SIDEWALK AND SHALL EXTEND VERTICALLY THROUGH THE FULL DEPTH OF THE CONCRETE. SLEEVES SHALL BE INSTALLED 14" BACK FROM THE FACE OF THE
- CURBING OR AT THE LOCATION(S) SPECIFIED BY THE ENGINEER. UNLESS SPECIFIED HEREIN OR OTHERWISE DIRECTED BY THE ENGINEER, ALL MATERIALS AND WORK SHALL CONFORM TO THE STATE OF CONNECTICUT, BUREAU OF HIGHWAYS, "STANDARDS SPECIFICATIONS FOR ROADS, BRIDGES AND INCIDENTAL CONSTRUCTION, FORM 819, LATEST REVISION," AND ASSOCIATED STANDARD DESIGN DETAILS SHEETS.

CONCRETE MONOLITHIC CURB & SIDEWALK



GRANULAR FILL OR RECLAIMED MISCELLANEOUS AGGREGATE BASE SHALL BE PLACED IN LAYERS NOT TO EXCEED 6 INCHES DEEP AND TO SUCH A DEPTH THAT AFTER COMPACTION IT SHALL BE AT THE SPECIFIED DEPTH BELOW THE FINISHED GRADE OF THE WALK. THE BASE SHALL BE WETTED AND ROLLED OR TAMPED AFTER SPREADING OF EACH LAYER. CONCRETE SIDEWALK THICKNESS SHALL BE AT LEAST 5" THICK. AREAS OF DRIVEWAY APRONS SHALL BE AT LEAST 8" THICK.

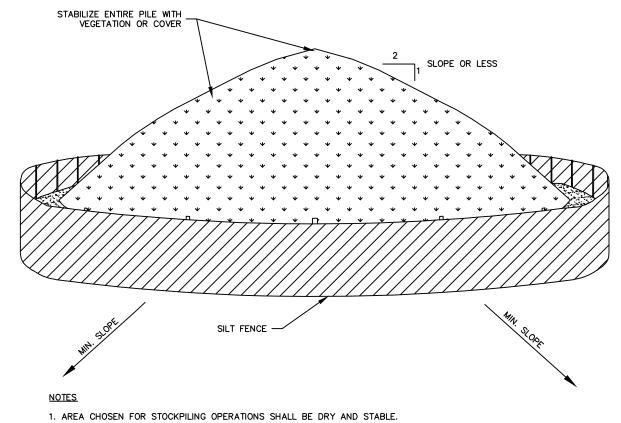
4400 P.S.I. AND 5" ENTRAINED AIR. 4. EXPANSION AND CONTRACTION JOINTS SHALL BE PROVIDED IN ACCORDANCE WITH THE SPECIFICATIONS OR AS OTHERWISE DIRECTED BY THE ENGINEER. AT A MINIMUM A CONTRACTION JOINT SHALL BE PLACED AT 5' INTERVALS WITH AN EXPANSION JOINT AT 20'

THE TOP-OUTER CORNER OF THE CURB. CONCRETE SHALL BE CLASS "C" HAVING A MINIMUM 28 DAY COMPRESSIVE STRENGTH OF

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- 5. THE TOTAL WIDTH OF CONCRETE CURBING AND SIDEWALK SHALL NOT BE LESS THAN 5'0" AT A ‡" PER FOOT CROSS PITCH, EXCEPT WHERE OTHERWISE DIRECTED BY THE TOWN ENGINEER.
- 6. CURBING EXTENDING ACROSS DRIVEWAYS SHALL PROVIDE A 2" REVEAL AT THE GUTTER LINE. THE SIDEWALK PANELS SHALL BE RAMPED AT DRIVEWAY CROSSINGS IN ACCORDANCE TO A.D.A. SPECIFICATIONS FOR HANDICAP ACCESS. AT NO POINT SHALL THE PITCH OF THE
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- BUT SHALL NOT BE LESS THAN 3" (12"+12") FOR ROADWAYS AND 2" FOR DRIVEWAYS.
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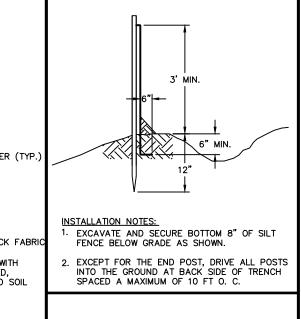
TEMPORARY SOIL STOCKPILE DETAIL



- 2. MAXIMUM SLOPE OF STOCKPILE SHALL BE 1:2.
- 3. UPON COMPLETION OF SOIL STOCKPILING, EACH PILE SHALL BE SURROUNDED WITH SILT FENCING, THEN STABILIZED WITH
- 4. SEE SPECIFICATIONS FOR INSTALLATION OF SILT FENCE.

INLET PROTECTION WITH SILTSACK 1" REBAR FOR BAG REMOVAL FROM INLET -(REBAR NOT INCLUDED) OPTIONAL OVERFLOW -SILTSACK (REBAR NOT INCLUDED) SIDE VIEW INSTALLED

PLANTING BED DETAIL DECIDUOUS TREE EVERGREEN TREE LEAVE 12" DIA. CIRCLE REMOVE BURLAP FROM TOP 1/3 OF BALL OF ALL TREES & " MULCH LAYER (TYP. 12" MIN ROOT BALL DIA. SET ROOTBALL ON

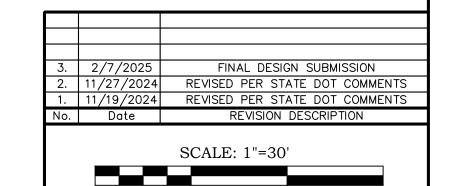


SILT FENCE

GENERAL NOTES

ANY EXCAVATION.

- 1. EXISTING INFORMATION OBTAINED FROM A FIELD SURVEY PERFORMED IN APRIL & MAY 2024, CONTOURS AND ELEVATIONS SHOWN HEREON REFER
- 2. A PORTION OF THE PARCEL LIES WITHIN FLOOD ZONE AE AS SHOWN ON FEMA FIRM MAP 09003C0203F, EFFECTIVE DATE SEPTEMBER 26, 2008.
- 3. LOCATION OF ALL UNDERGROUND UTILITIES DEPICTED HEREON ARE APPROXIMATE AND ARE BASED ON FIELD LOCATION OF VISIBLE STRUCTURES SUCH AS CATCH BASINS, MANHOLES, WATER GATES, ETC., COMPILING INFORMATION FROM PLANS SUPPLIED BY THE RESPECTIVE UTILITY COMPANIES AND GOVERNMENT AGENCIES. ALL CONTRACTORS ARE REQUIRED BY STATE REGULATIONS TO CONTACT CALL-BEFORE-YOU-DIG AT 1-800-922-4455 FOR LOCATION AND STAKEOUT OF UTILITIES PRIOR TO
- 4. IF THERE ARE ANY VARIATIONS ON THIS MAP WITH WHAT IS FOUND OR DESIRED IN THE FIELD. THE CONTRACTOR SHALL CONTACT AND NOTIFY THE SITE ENGINEER IMMEDIATELY PRIOR TO COMMENCING THE RELATED WORK TO DETERMINE THE CORRECT COURSE
- 5. B&B ENGINEERING, LLC MAKES NO GUARANTEE WITH THIS PLAN UNLESS B&B INSPECTS ALL ASPECTS OF CONSTRUCTION.
- 6. ALL PROPOSED SIDEWALKS AND RAMPS SHALL CONFORM TO ADA STANDARDS.





15 Research Driv Woodbridge, CT 06525 P: (203) 881-8145 www.bbengrs.com

Land Surveying, Professional Engineering & Land Use Consultants

CONSTRUCTION NOTES AND DETAILS I

TOWN CAMPUS SIDEWALK CONNECTIONS

PREPARED FOR TOWN OF EAST GRANBY 9 CENTER STREET

EAST GRANBY, CONNECTICUT 06026

Date 5/29/2024 TO THE BEST OF MY KNOWLEDGE AND BELIEF THIS MAP IS SUBSTANTIALLY CORRECT AS NOTED HEREON. 1"=30 1419

Job No.



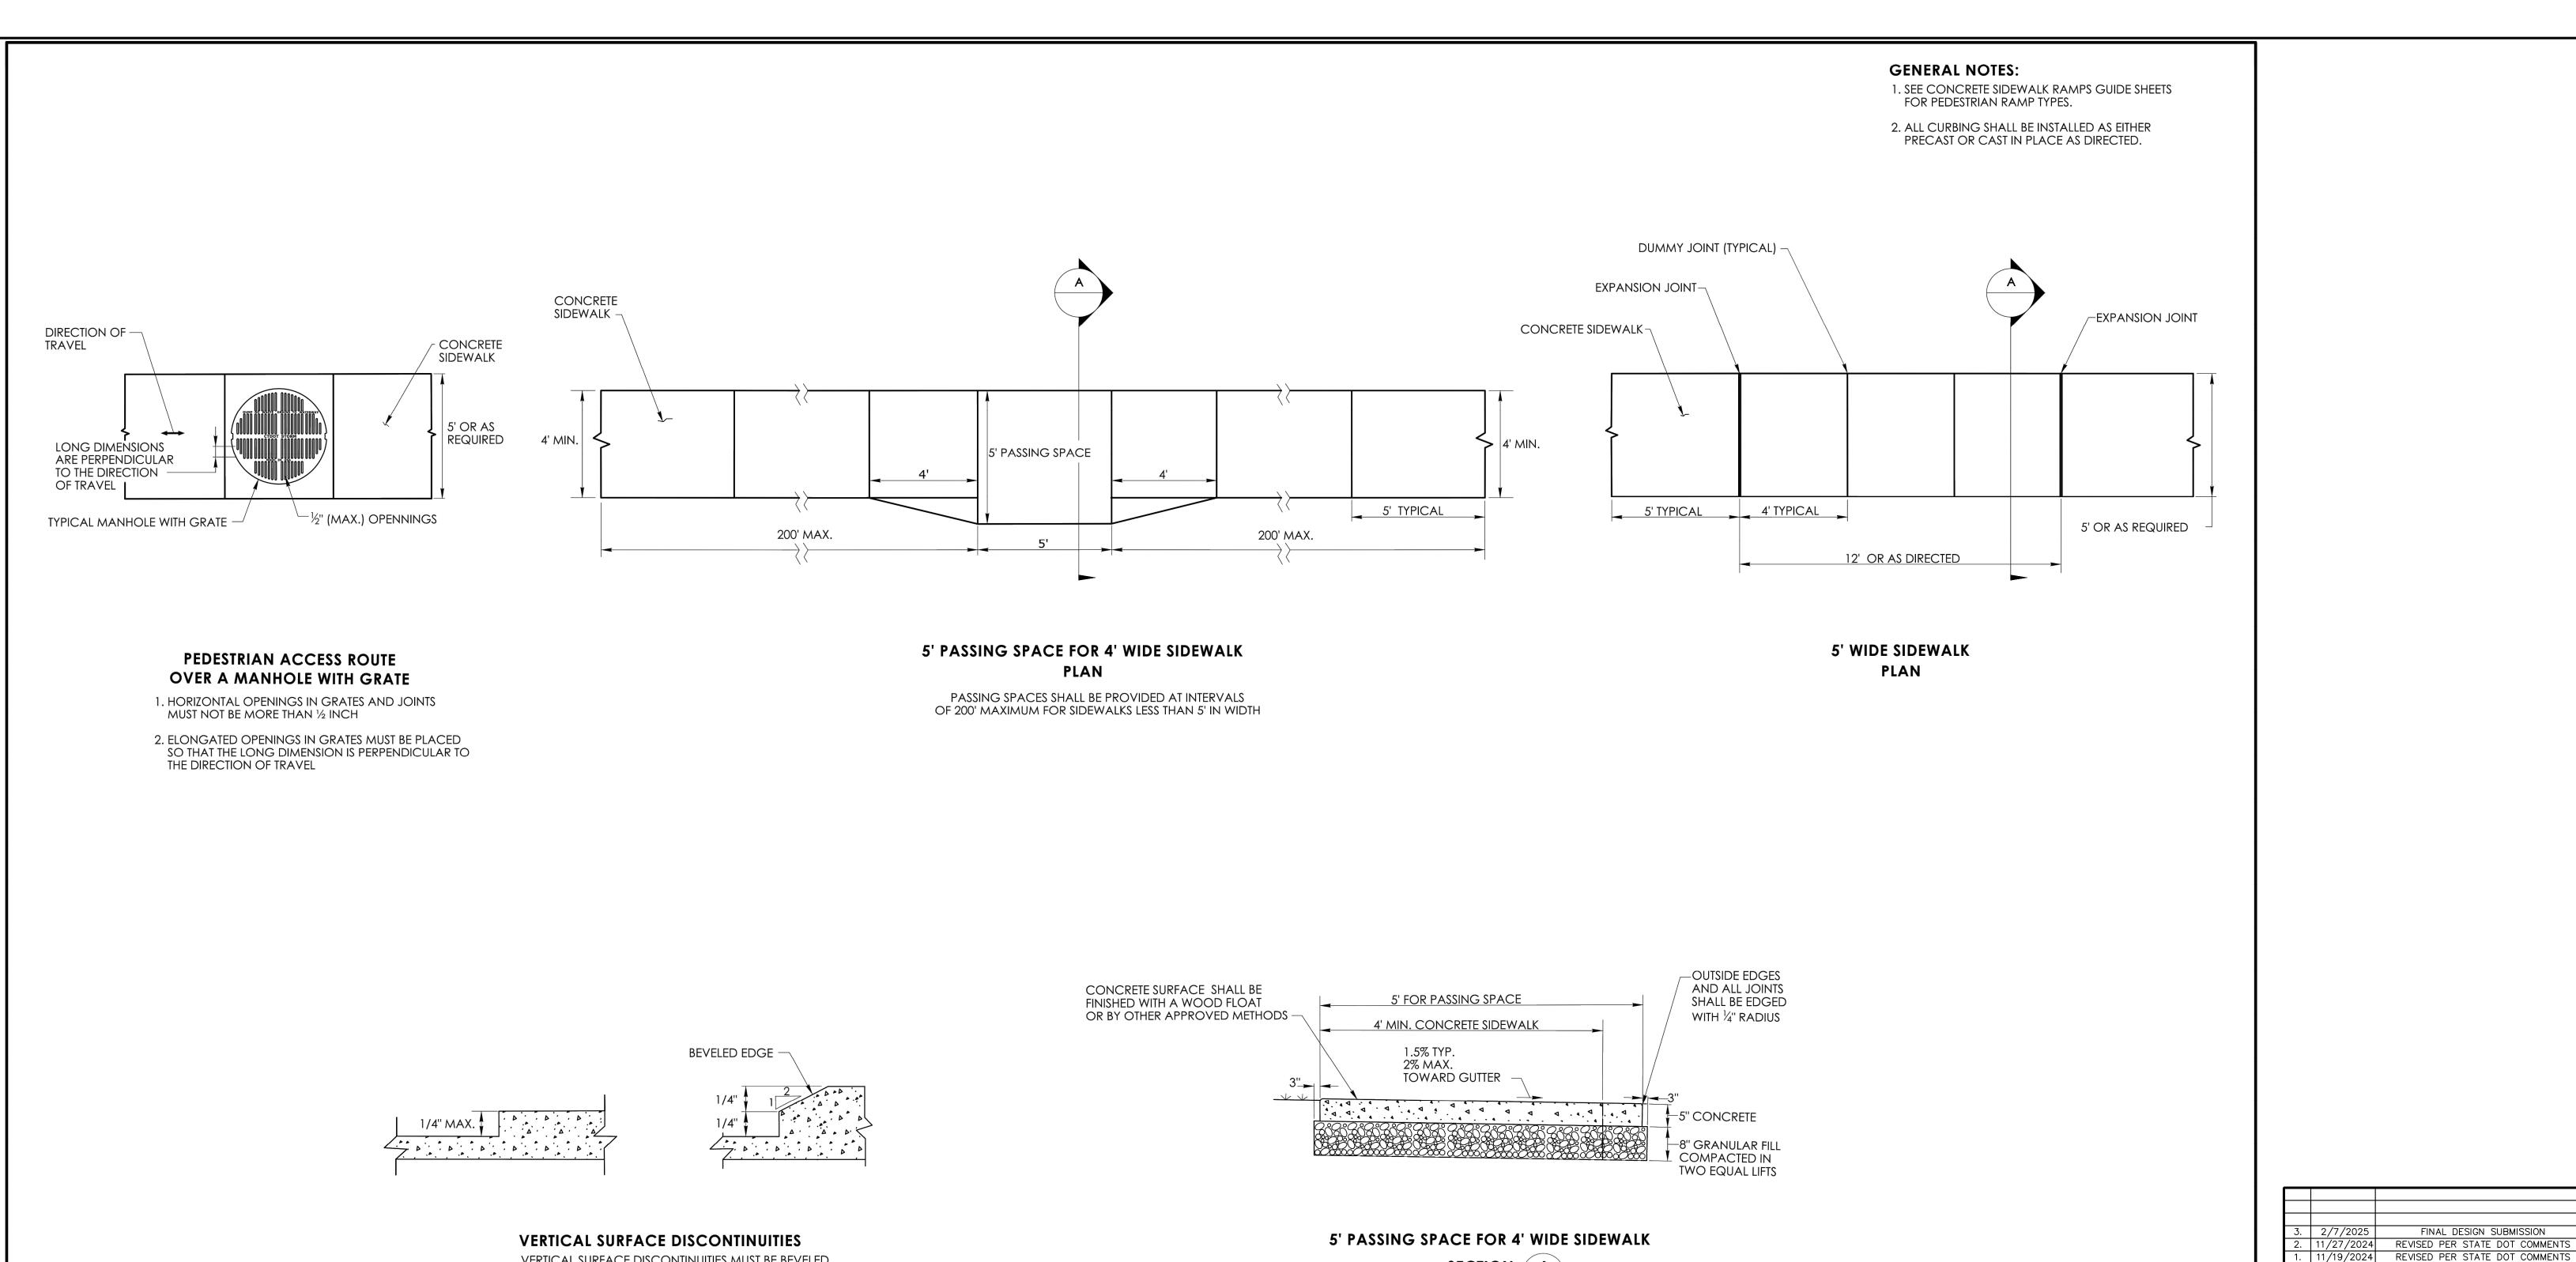
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INSTALLATION DETAIL

DRAWING LIST EXISTING CONDITIONS PLANS SITE LAYOUT PLANS GRADING PLANS SOIL EROSION & SEDIMENT CONTROL PLAN CONSTRUCTION NOTES & DETAILS

RYAM P. NESTERIAK, CT. P.E.,L.S. 23556



SECTION A

SIGNATURE BLOCK: SUBMITTED BY: APPROVED BY: STATE OF CONNECTICUT **CTDOT** Digitally signed by Leo Fontaine, P.E. Date: 2022.09.27
15:15:58-04'00'

Digitally signed by by Calabrese Michael Date: 2022.09:42:54-OFFICE OF ENGINEERING Digitally signed by Calabrese, CONCRETE SIDEWALKS NOT TO SCALE **DEPARTMENT** HW-921_01 2800 BERLIN TURNPIKE STANDARD SHEET OF NEWINGTON, CT 06111 Date: 2022.11.08 09:42:54-05'00' **TRANSPORTATION**

VERTICAL SURFACE DISCONTINUITIES MUST BE BEVELED

TO A HEIGHT NOT GREATER THAN 1/4 INCH. THE BEVEL MUST BE THE ENTIRE WIDTH OF THE DISCONTINUITY

PLOTTED DATE: 9/23/2022

DRAWING NAME
COVER SHEET
EXISTING CONDITIONS PLANS
SITE LAYOUT PLANS
GRADING PLANS
SOIL EROSION & SEDIMENT CONTROL PLAN
CONSTRUCTION NOTES & DETAILS

TO THE BEST OF MY KNOWLEDGE AND BELIEF THIS MAP IS SUBSTANTIALLY CORRECT AS NOTED HEREON.

1"=30 1419 Job No. Drawing No.

Date 5/29/2024

FINAL DESIGN SUBMISSION

15 Research Driv

Woodbridge, CT 06525 P: (203) 881-8145 www.bbengrs.com

No. Date REVISION DESCRIPTION

SCALE: 1"=30'

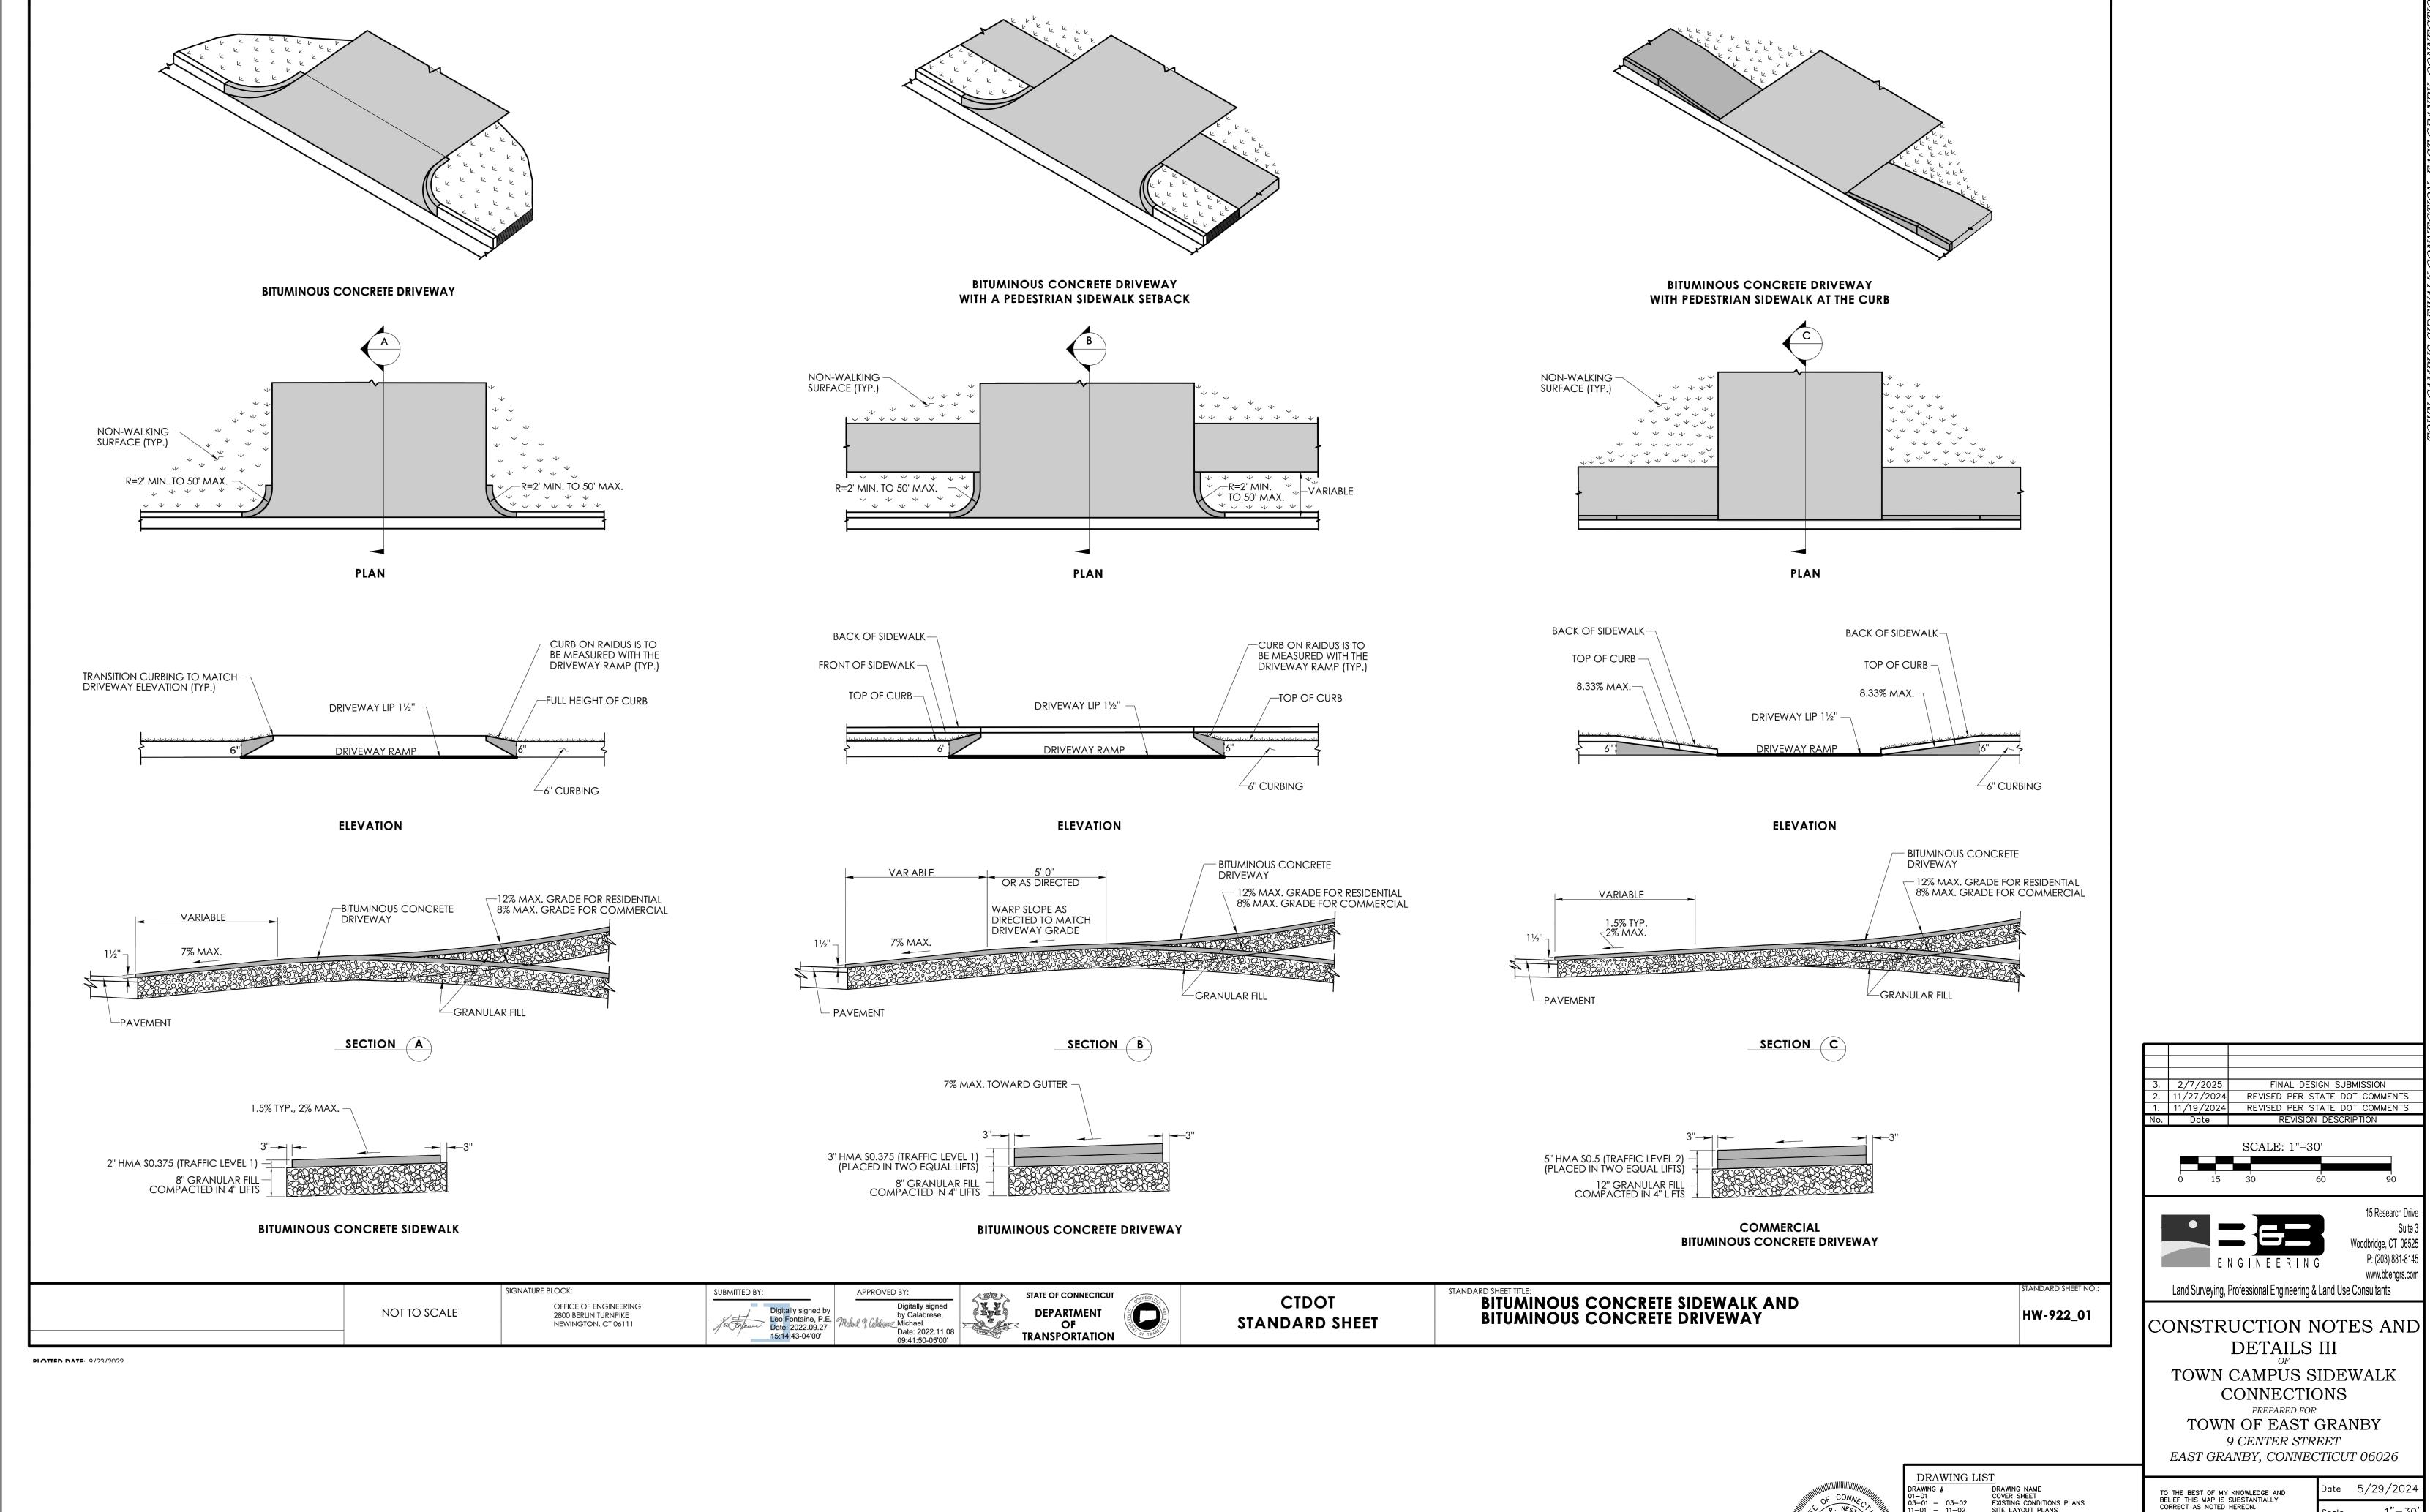
Land Surveying, Professional Engineering & Land Use Consultants

CONSTRUCTION NOTES AND

DETAILS II

TOWN CAMPUS SIDEWALK

CONNECTIONS PREPARED FOR TOWN OF EAST GRANBY 9 CENTER STREET EAST GRANBY, CONNECTICUT 06026

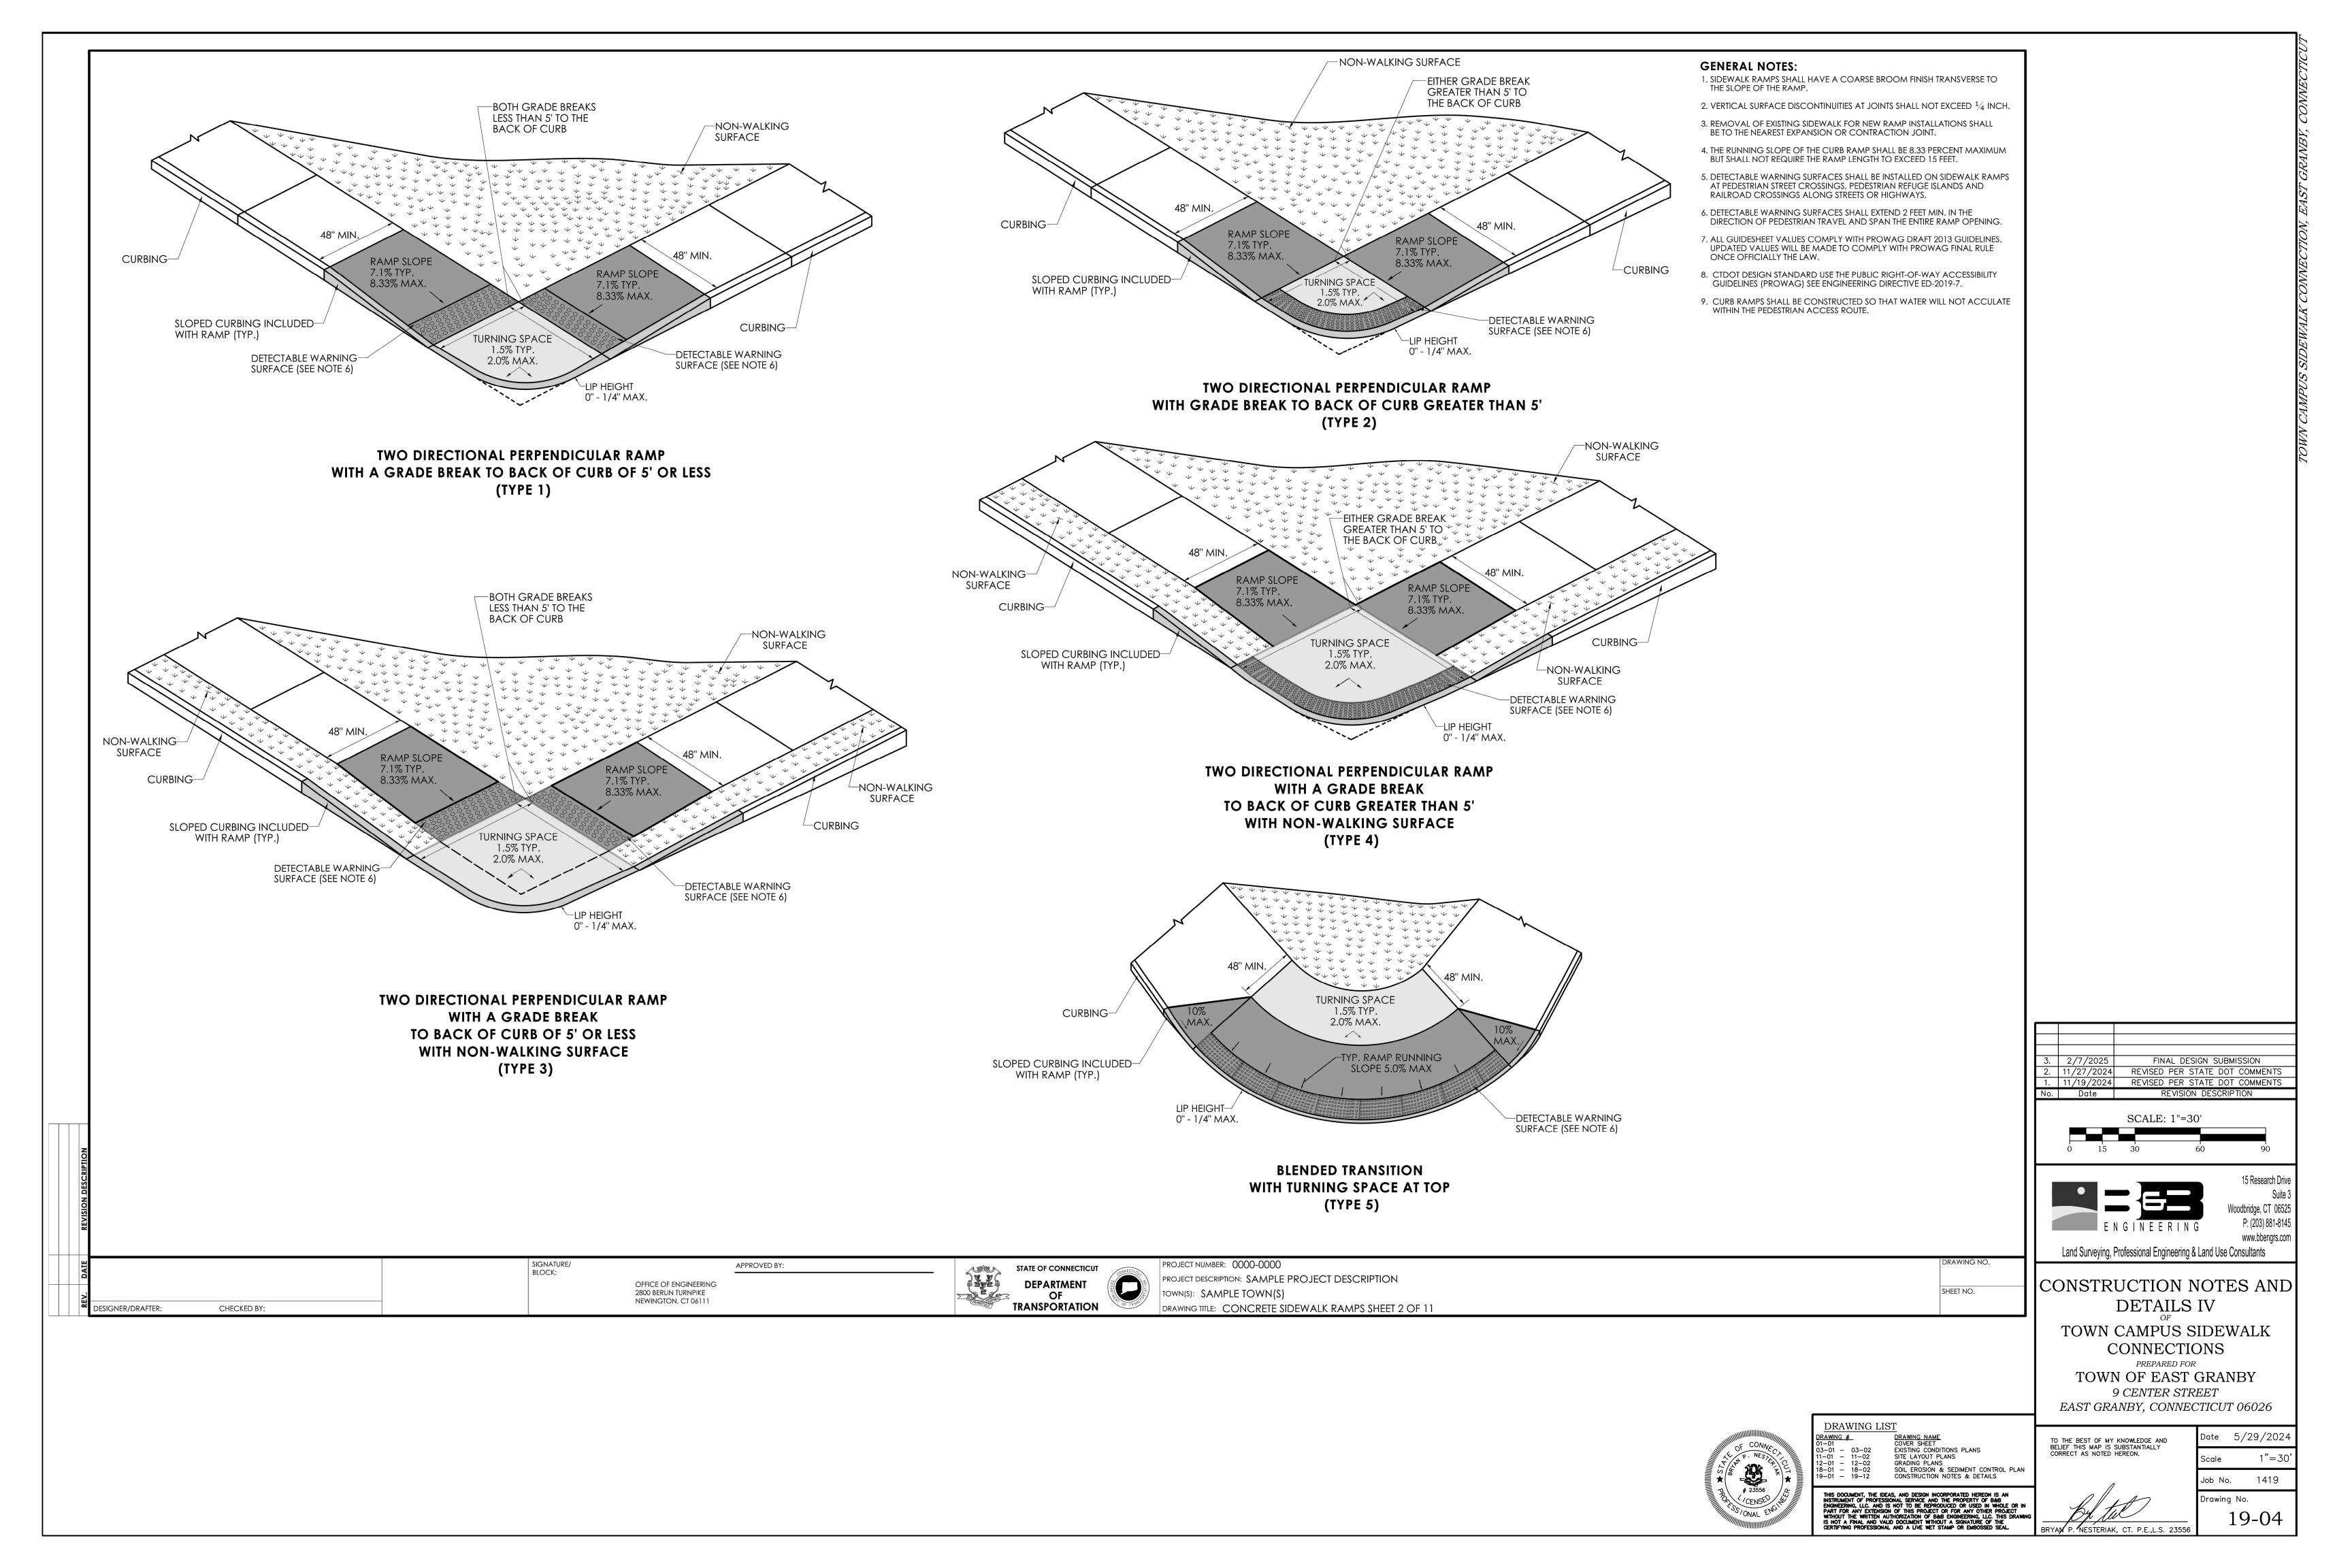


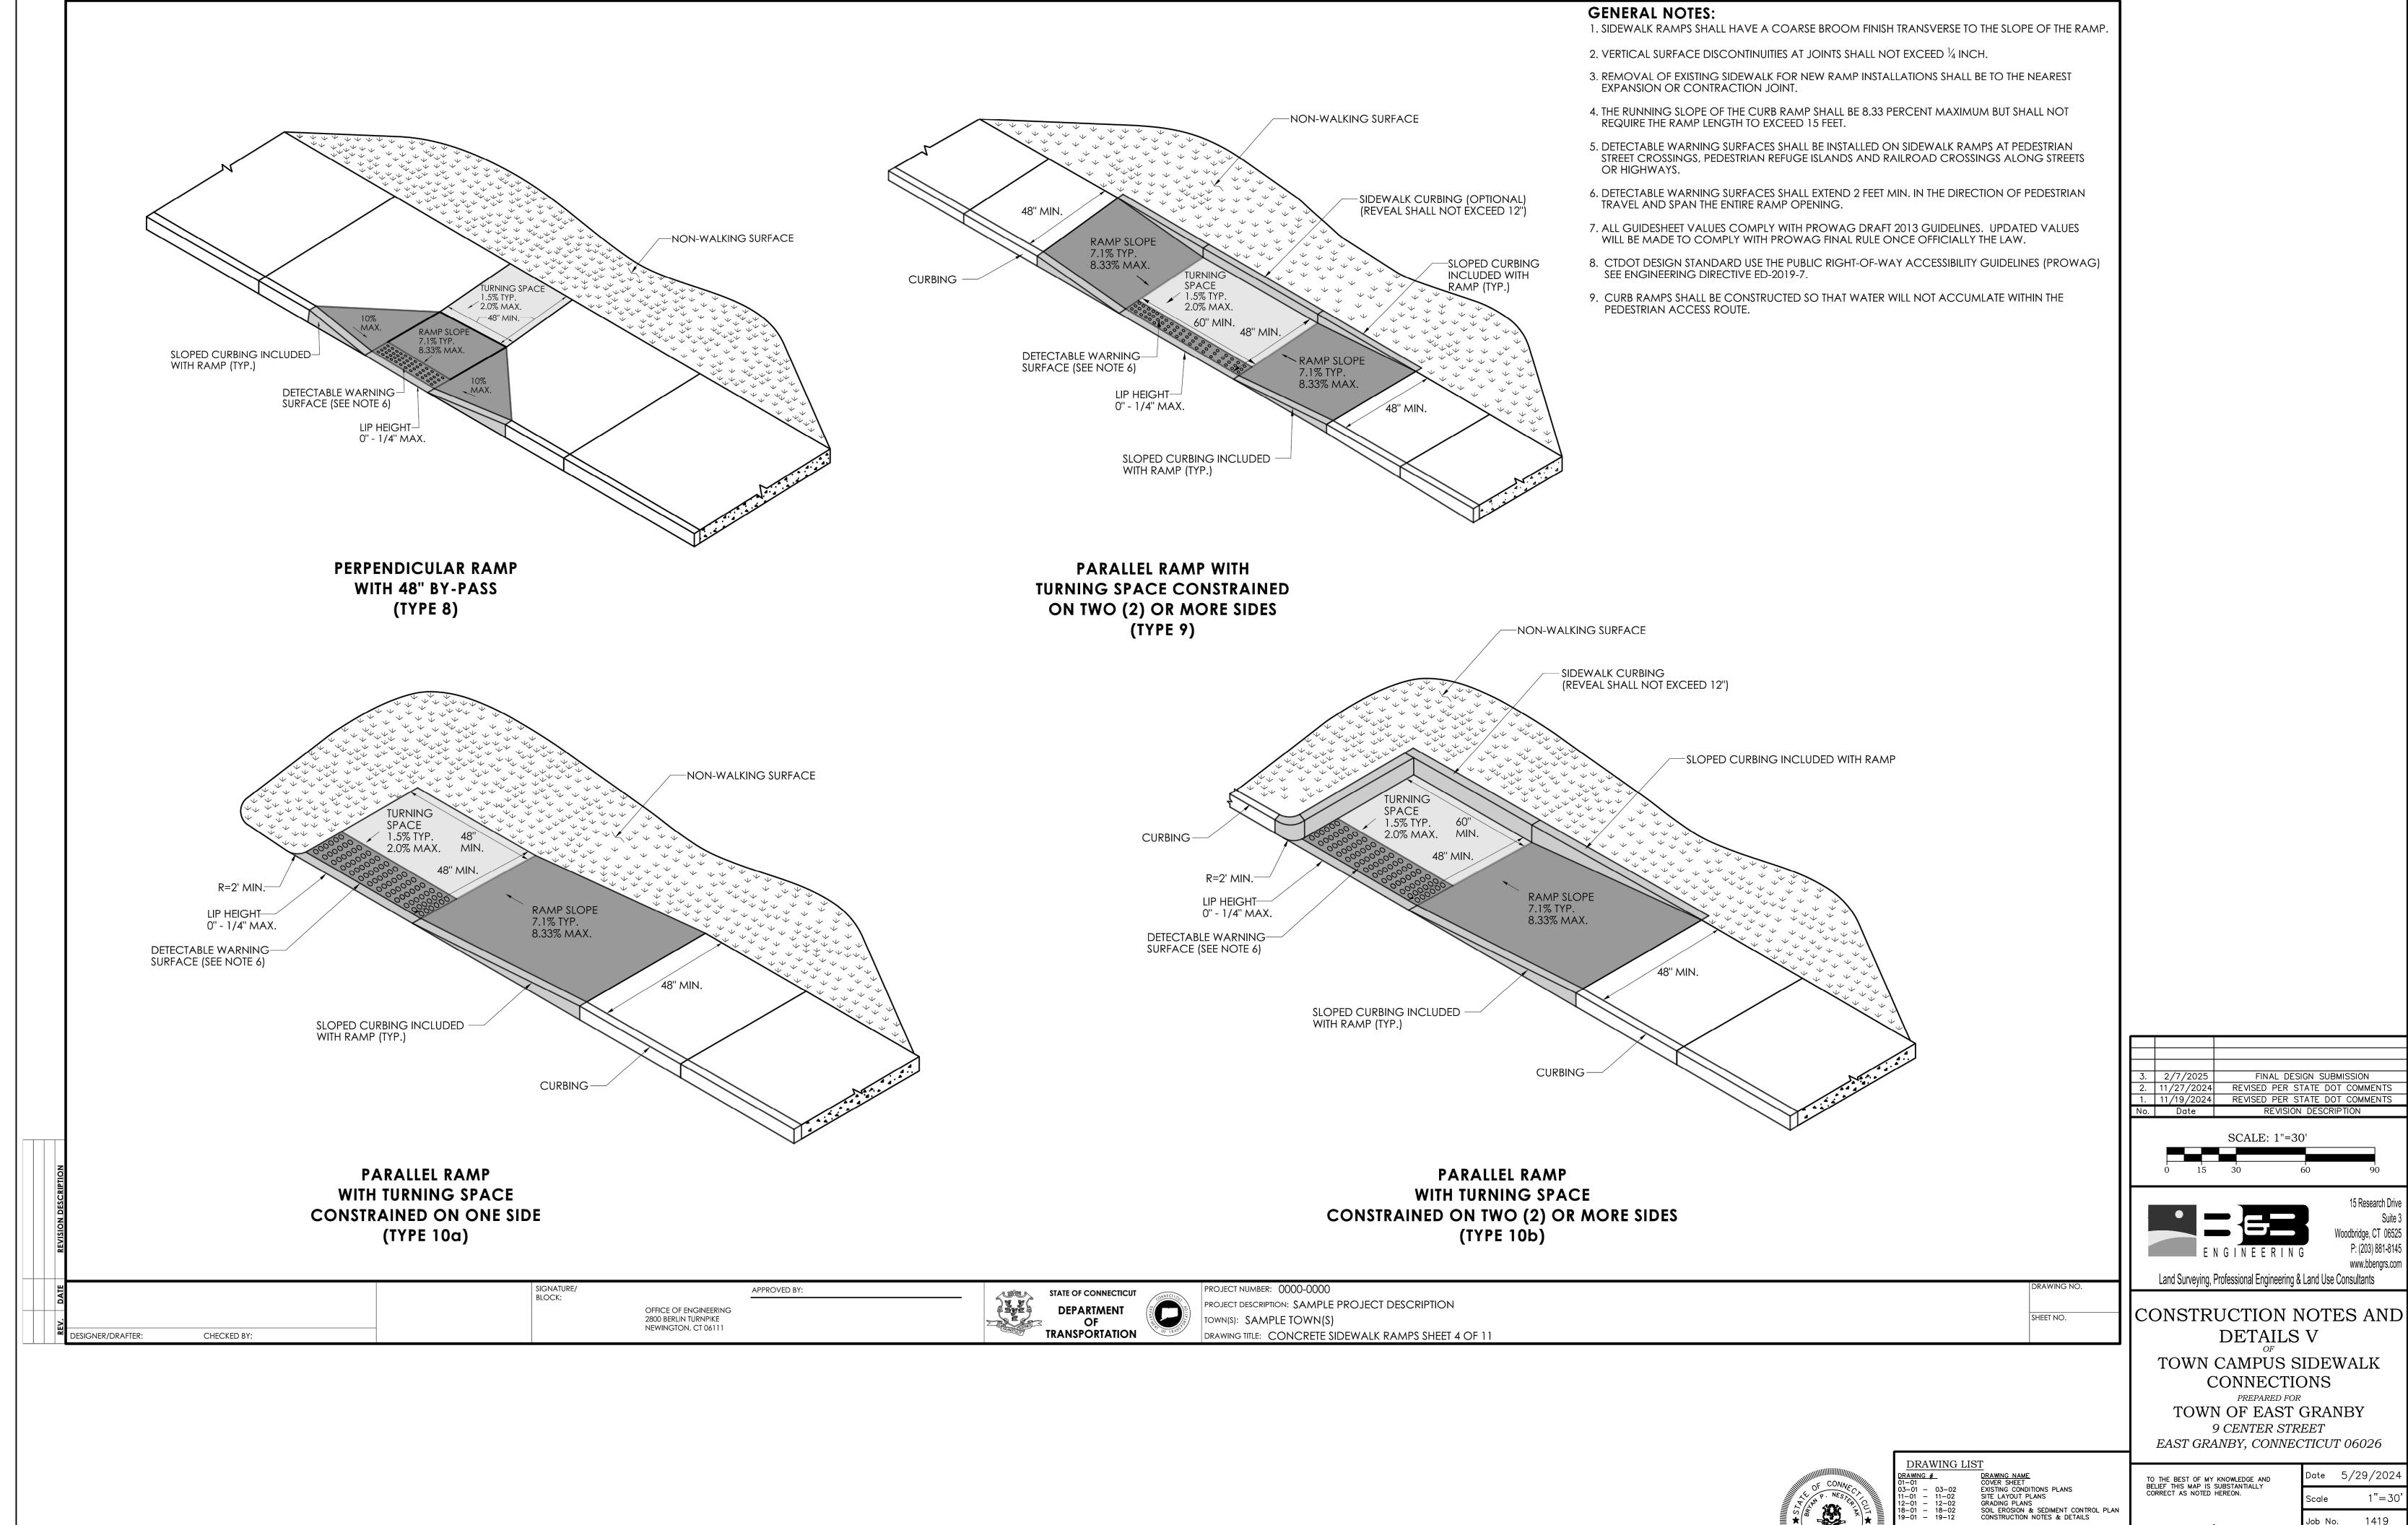


DRAWING NAME
COVER SHEET
EXISTING CONDITIONS PLANS
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CONSTRUCTION NOTES & DETAILS

1"=30 1419 Job No. Drawing No.

BRYAN P. NESTERIAK, CT. P.E.,L.S. 23556

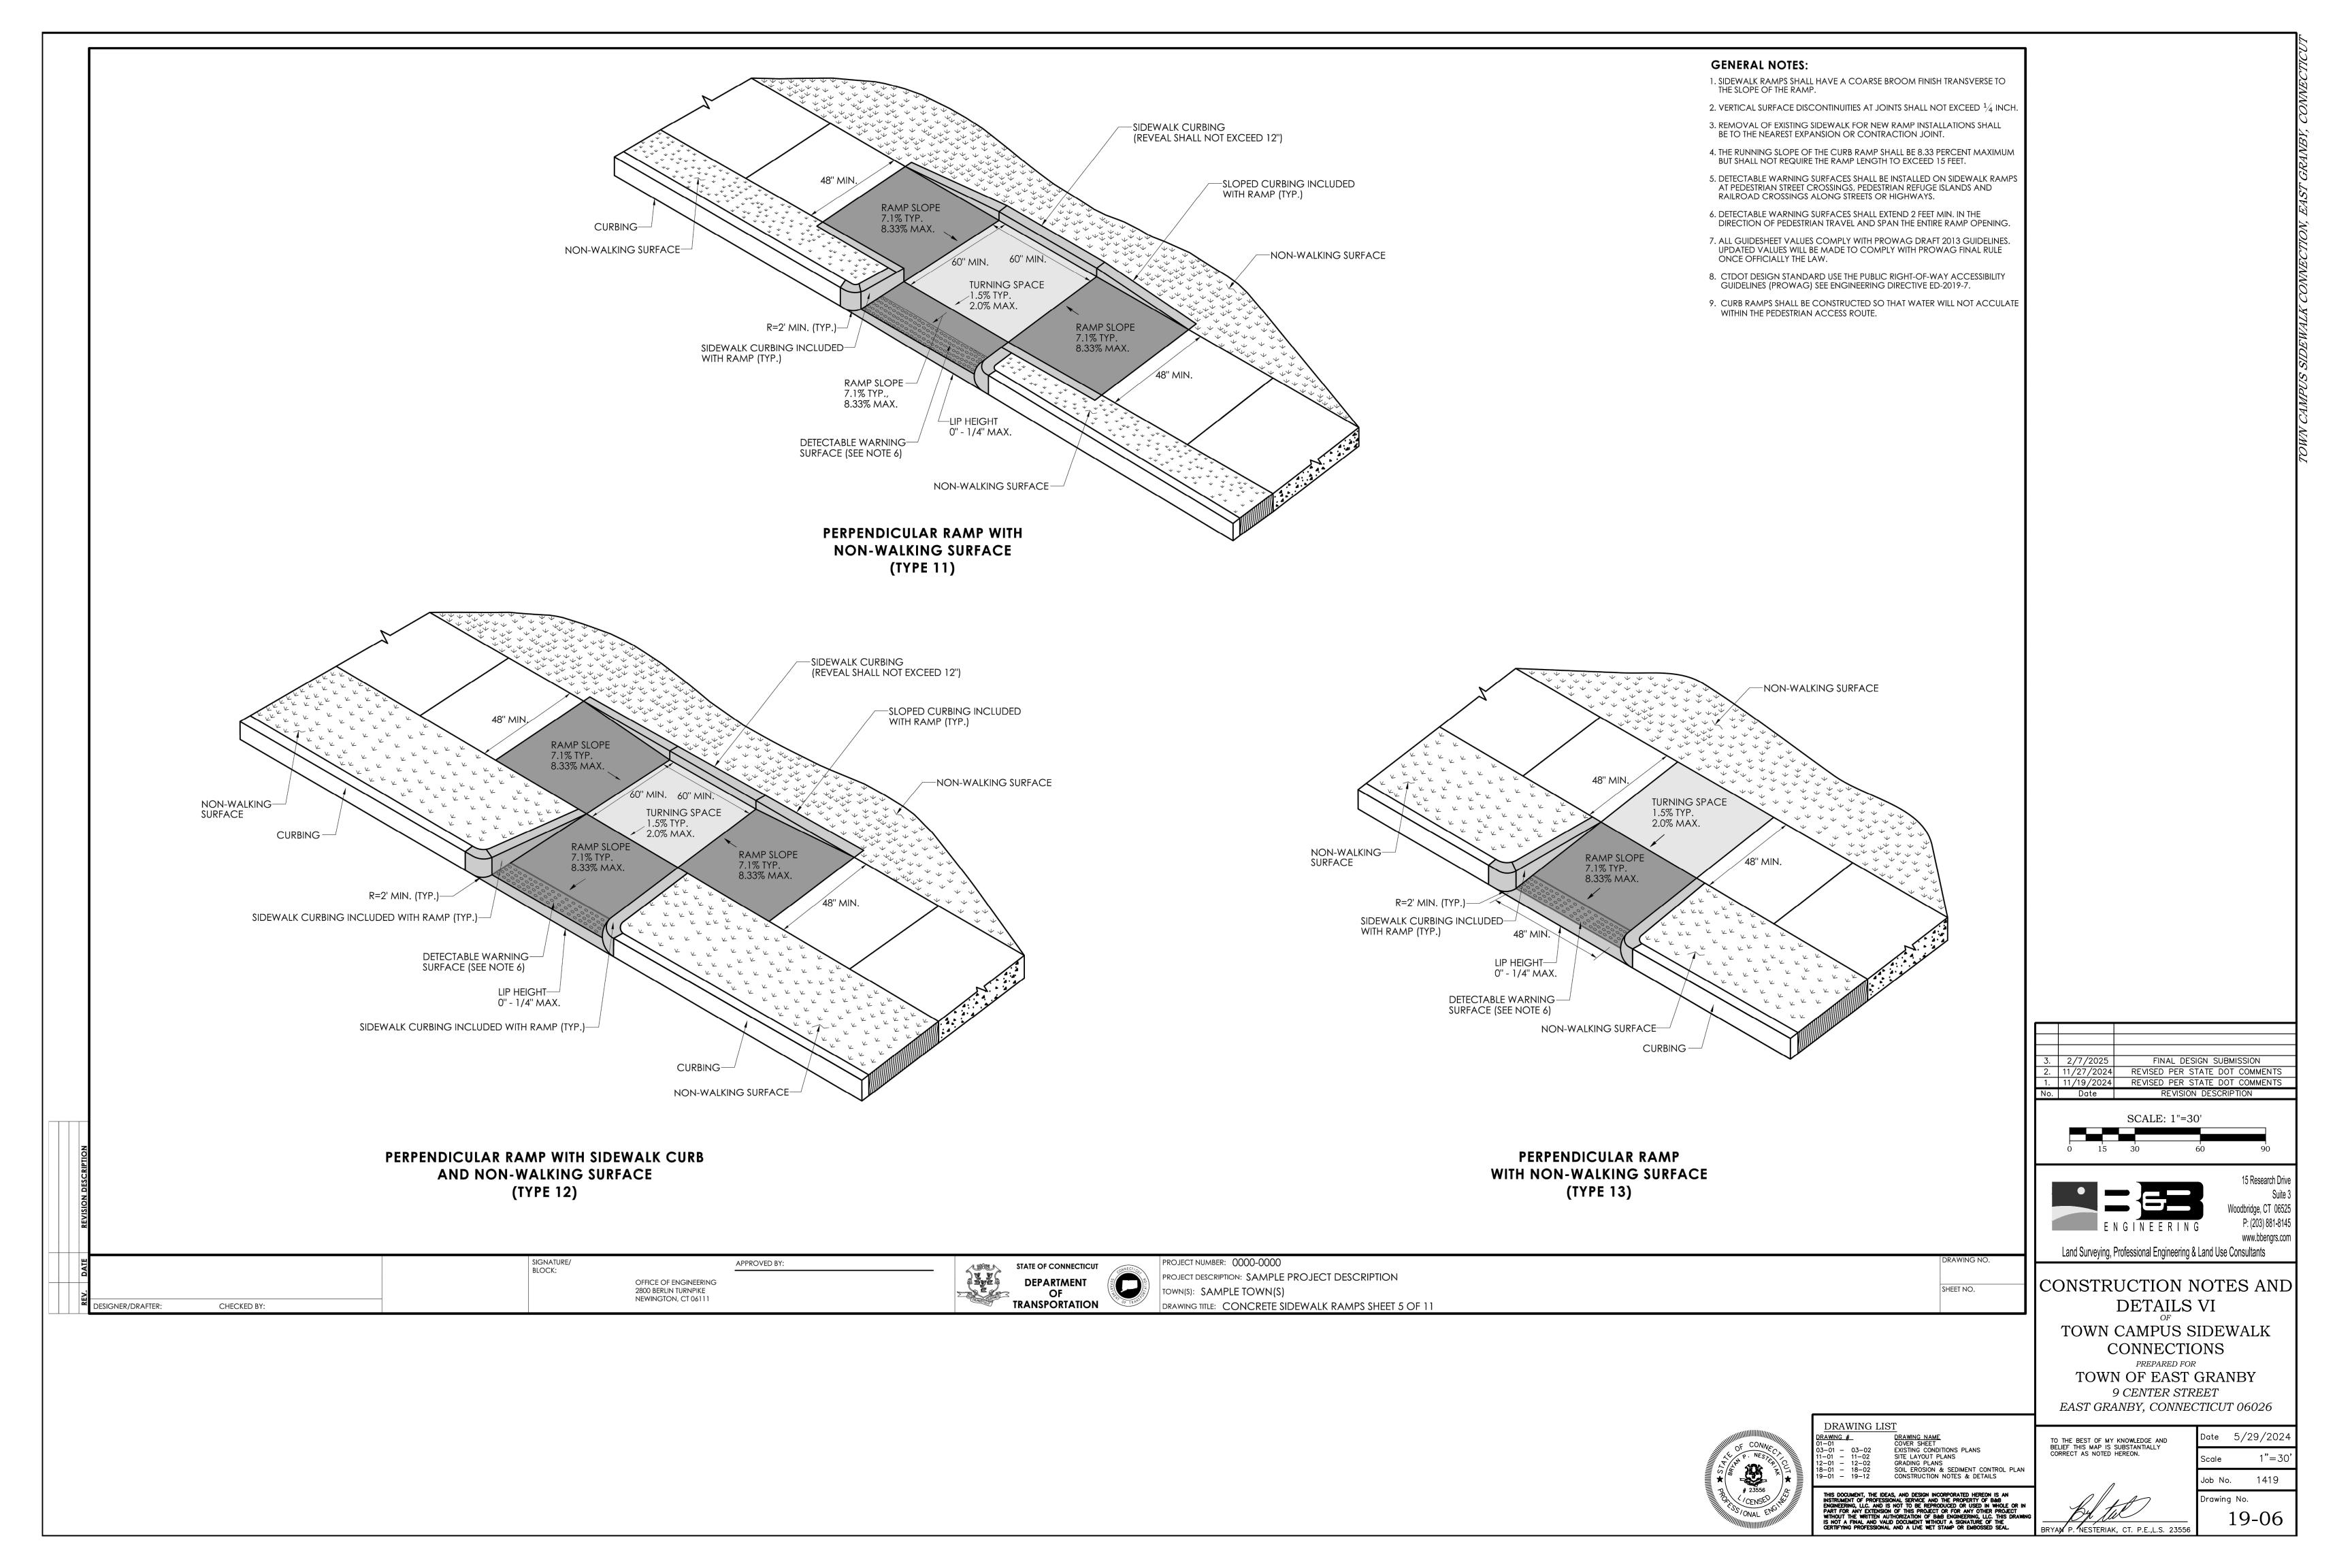


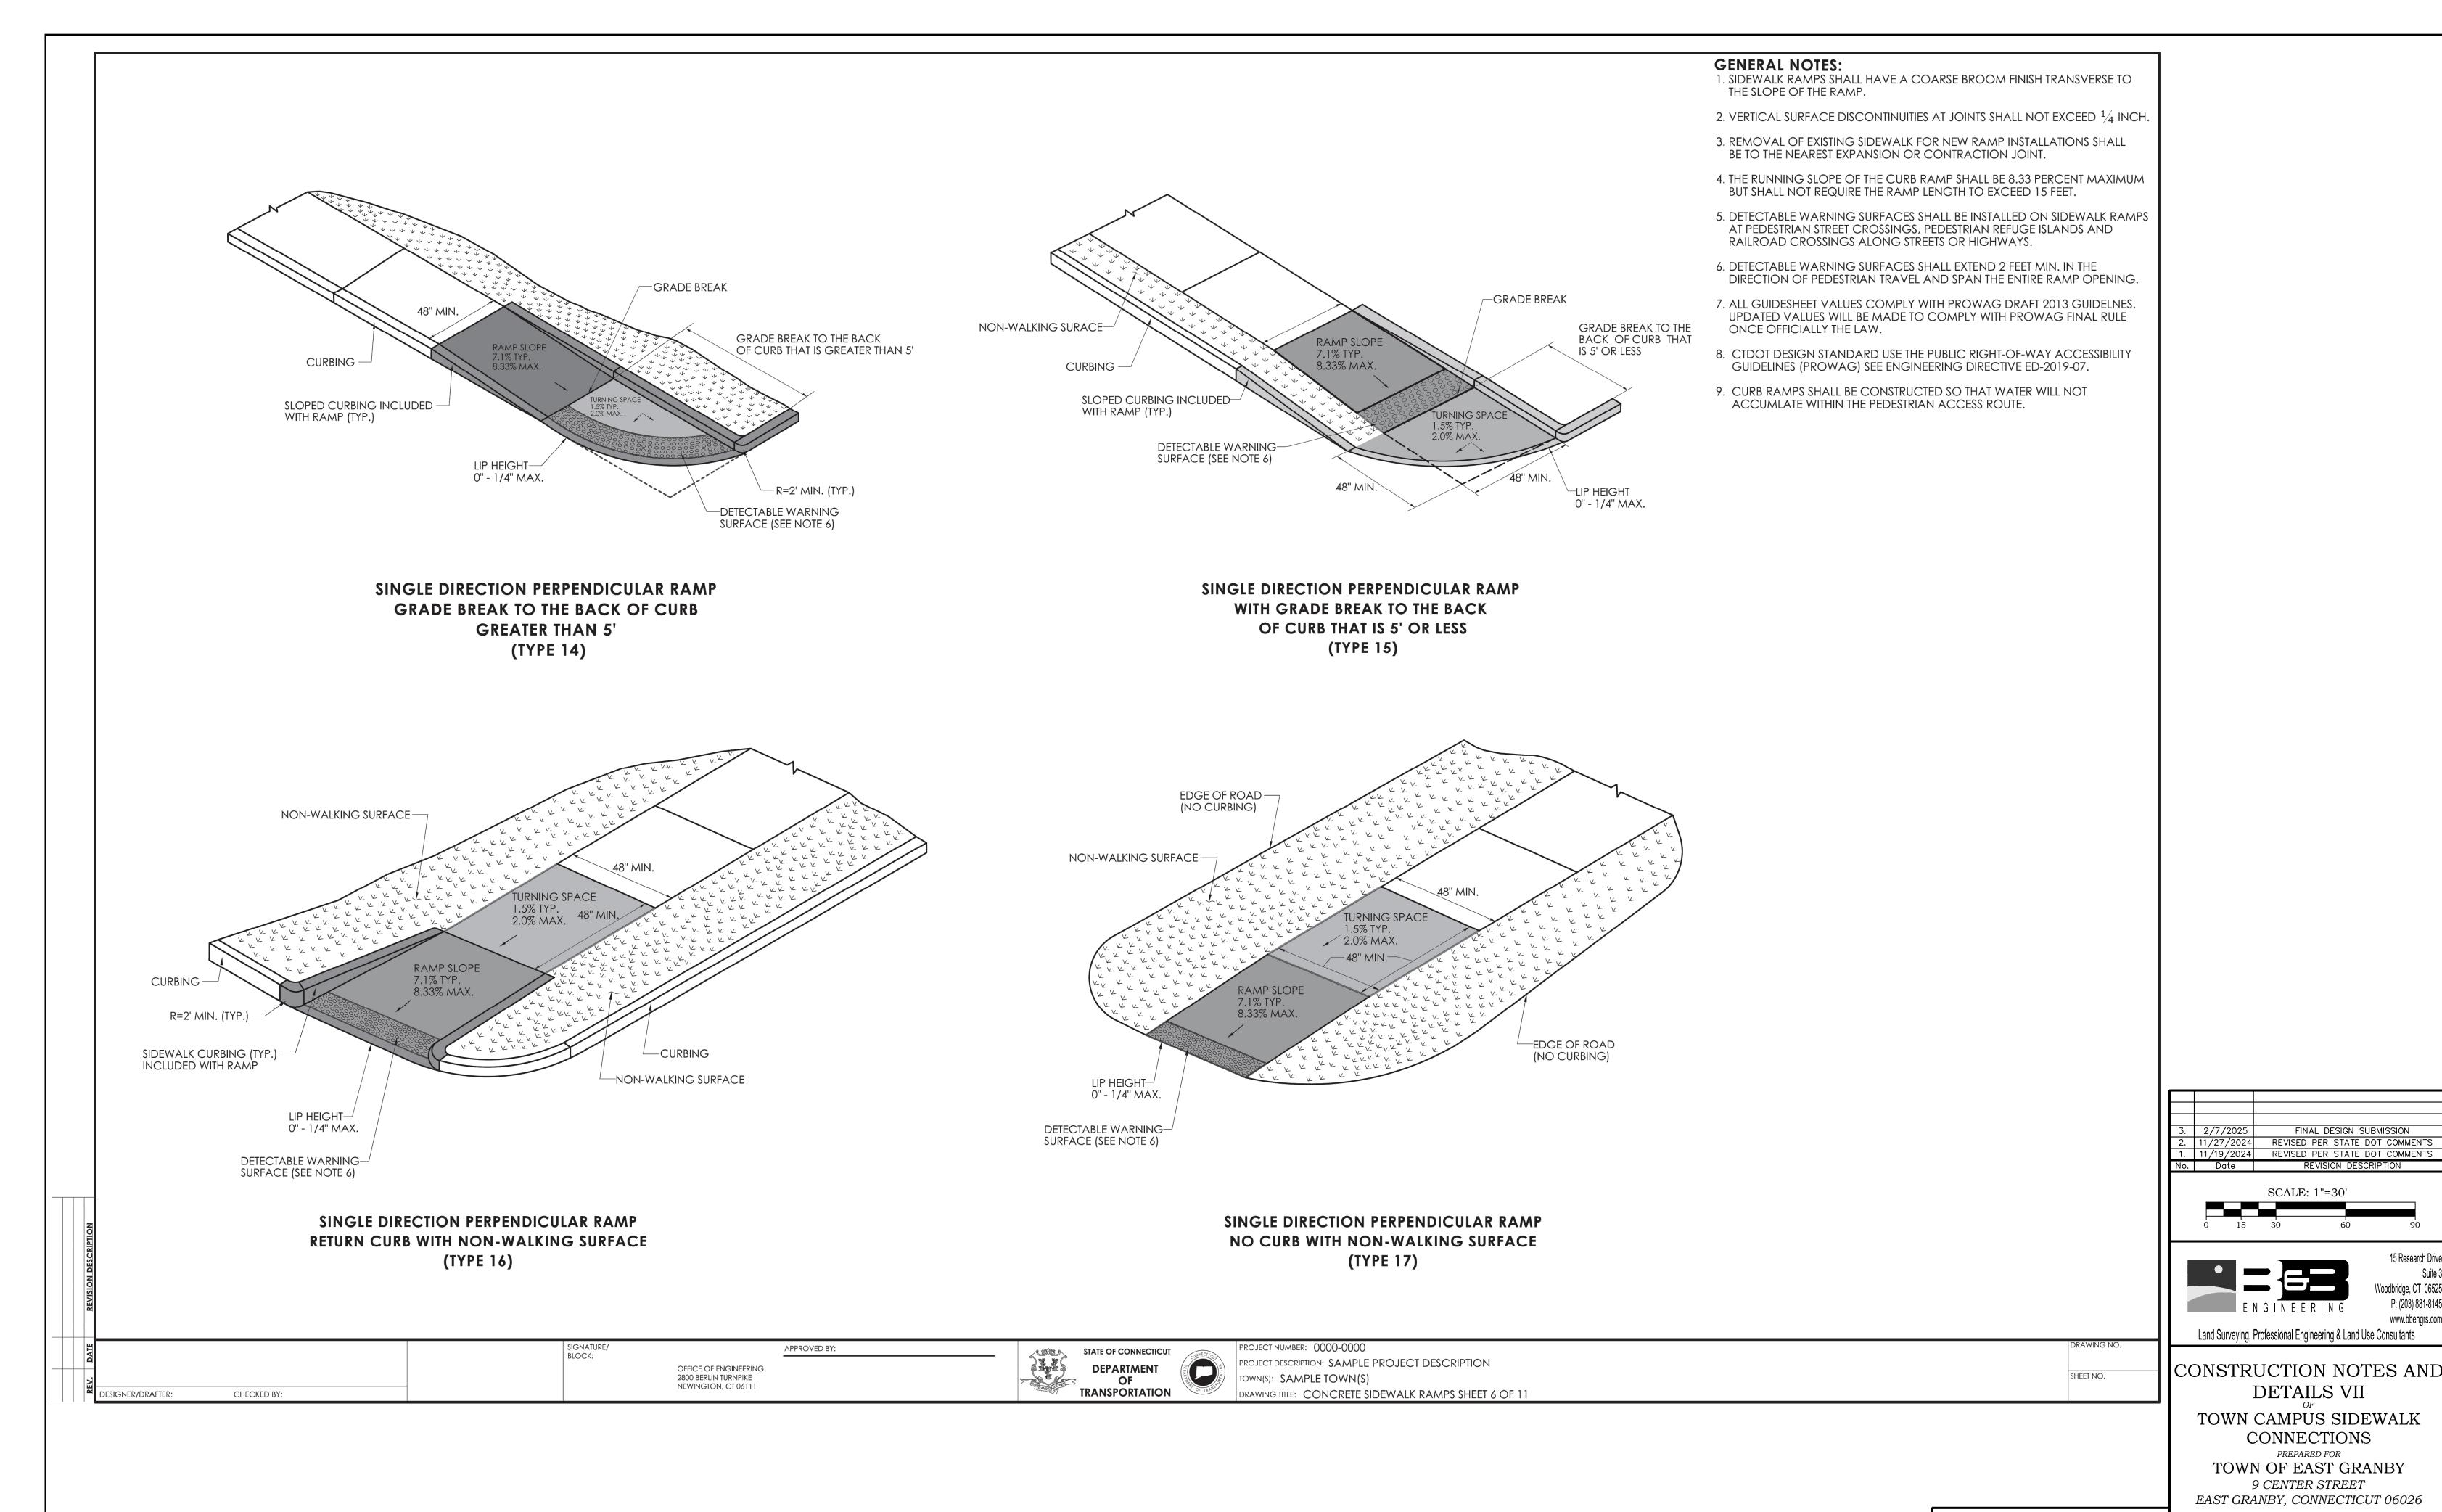


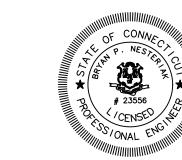


Job No. 1419 Drawing No.

19-05







DRAWING NAME
COVER SHEET
EXISTING CONDITIONS PLANS
SITE LAYOUT PLANS
GRADING PLANS
SOIL EROSION & SEDIMENT CONTROL PLAN
CONSTRUCTION NOTES & DETAILS

TO THE BEST OF MY KNOWLEDGE AND BELIEF THIS MAP IS SUBSTANTIALLY CORRECT AS NOTED HEREON. 1"=30 1419

FINAL DESIGN SUBMISSION

15 Research Driv

P: (203) 881-8145

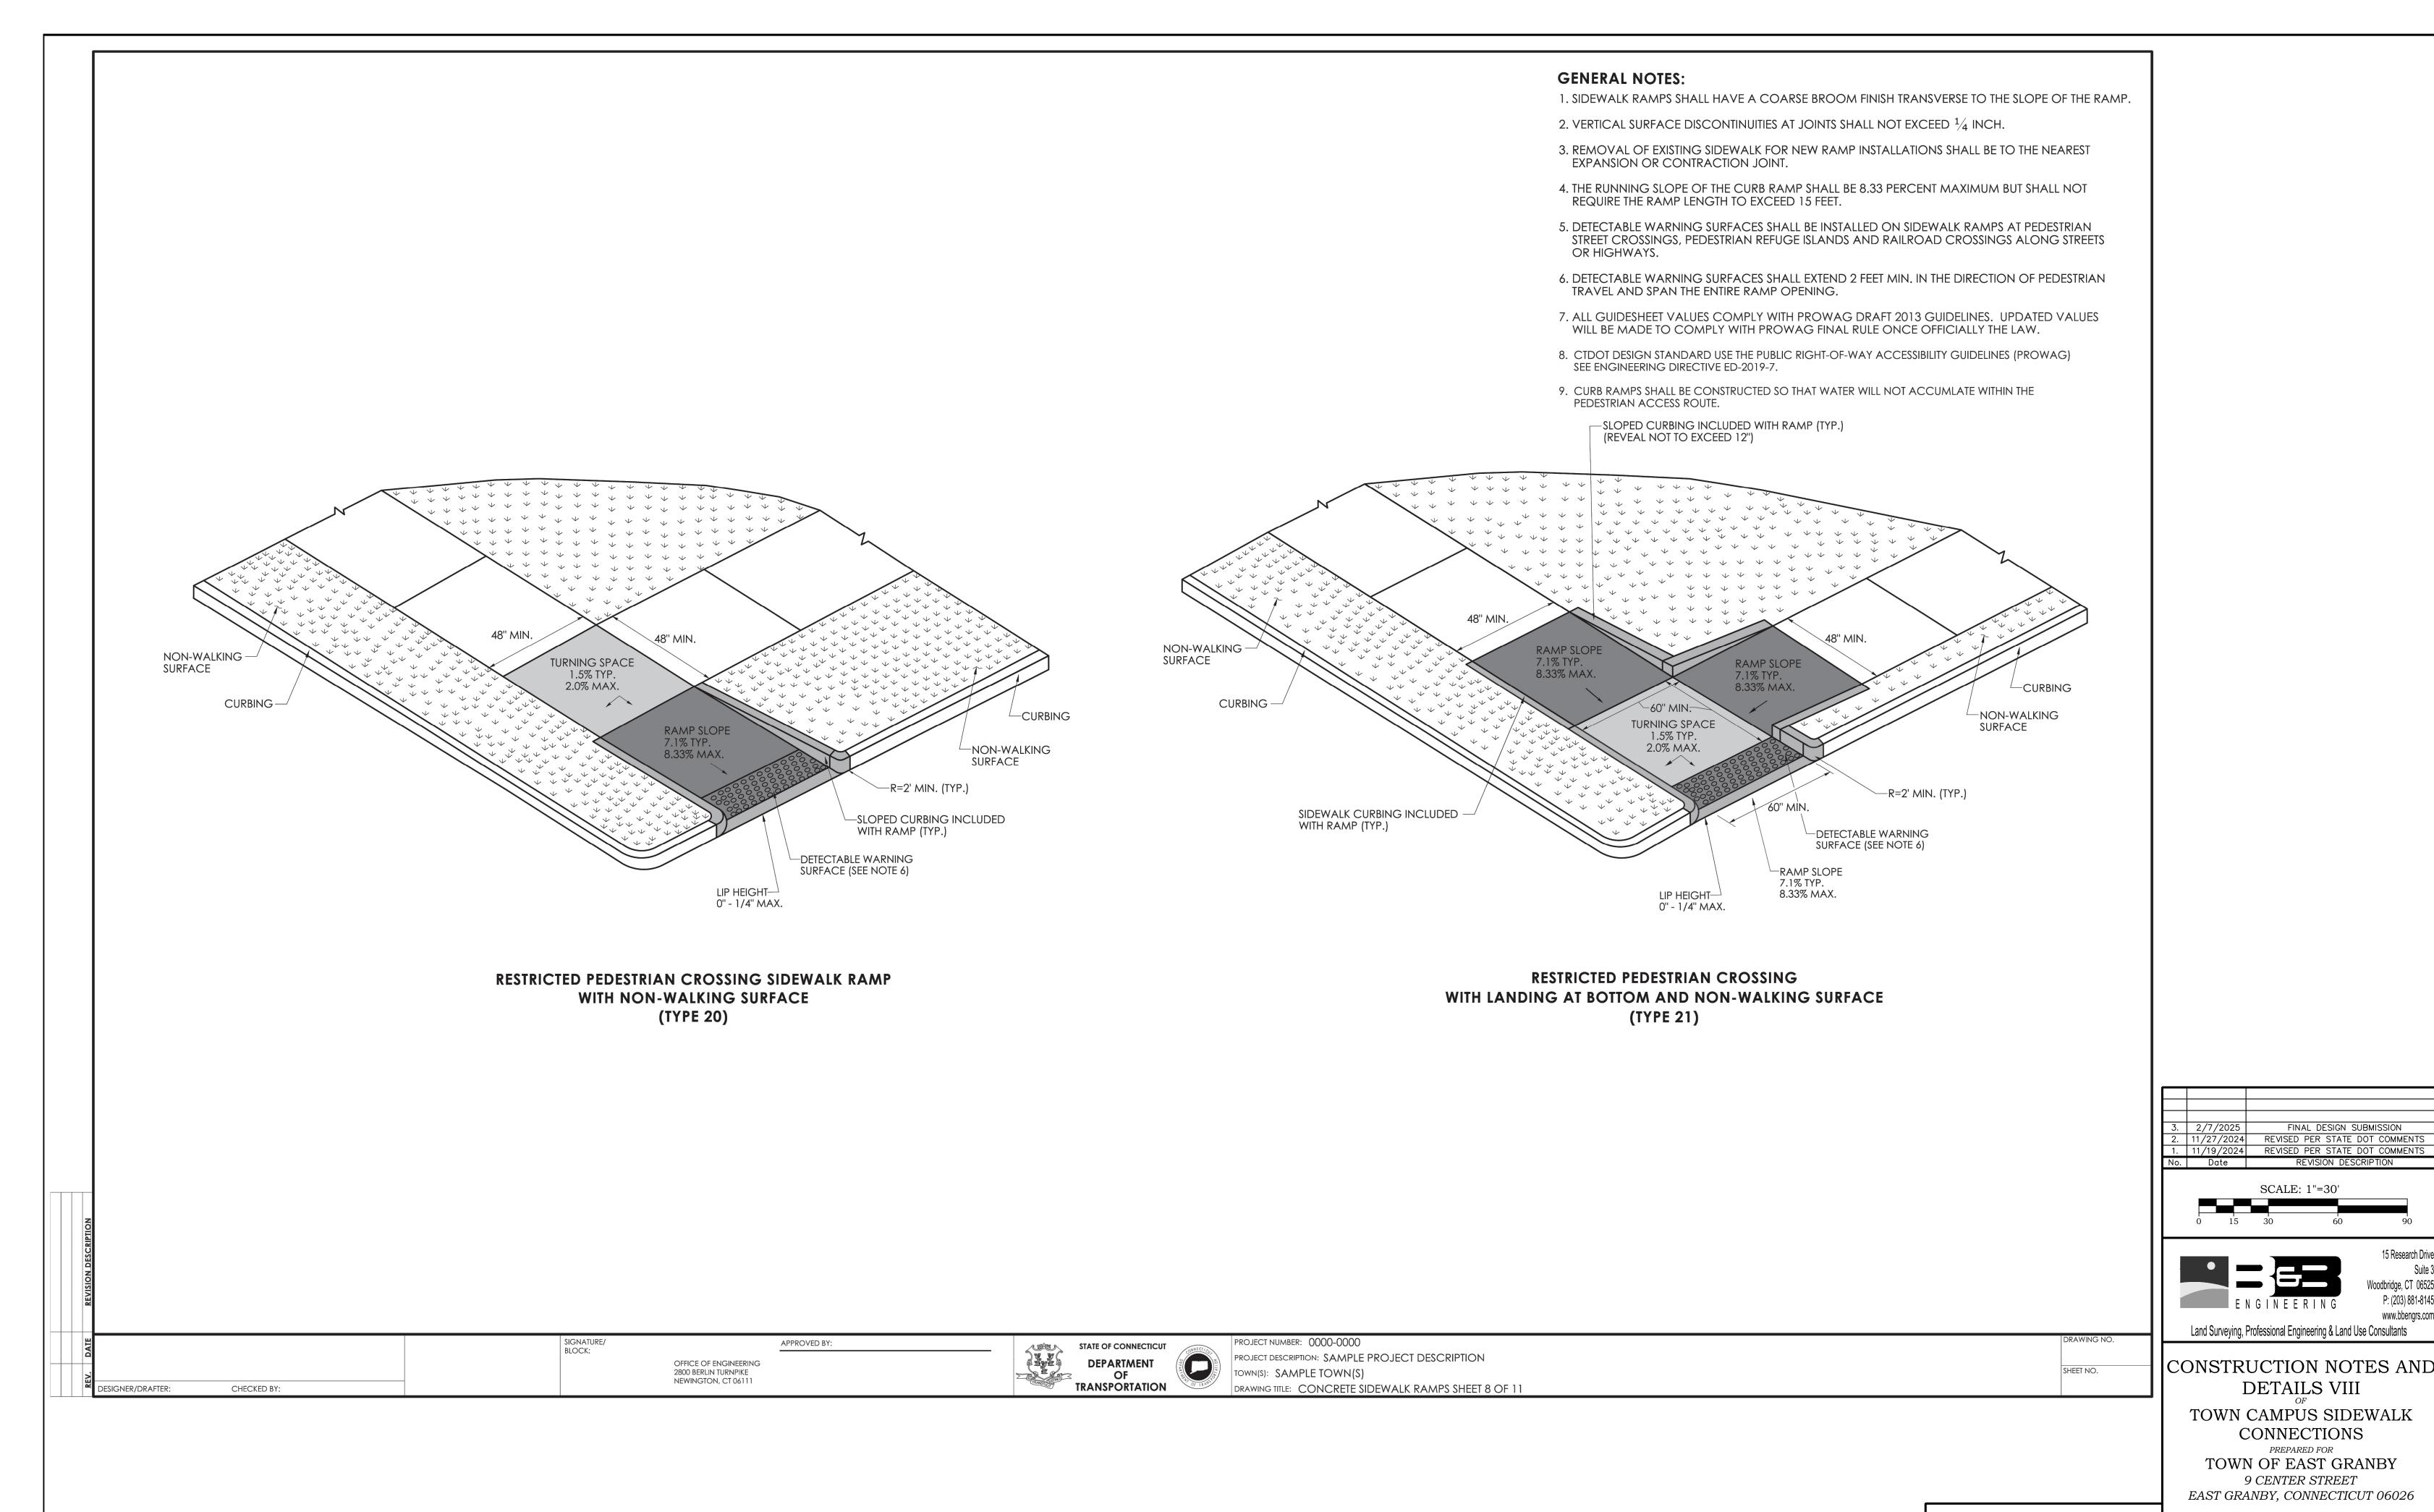
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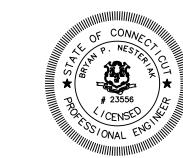
DETAILS VII

CONNECTIONS PREPARED FOR

9 CENTER STREET

Drawing No.





DRAWING NAME
COVER SHEET
EXISTING CONDITIONS PLANS
SITE LAYOUT PLANS
GRADING PLANS
SOIL EROSION & SEDIMENT CONTROL PLAN
CONSTRUCTION NOTES & DETAILS

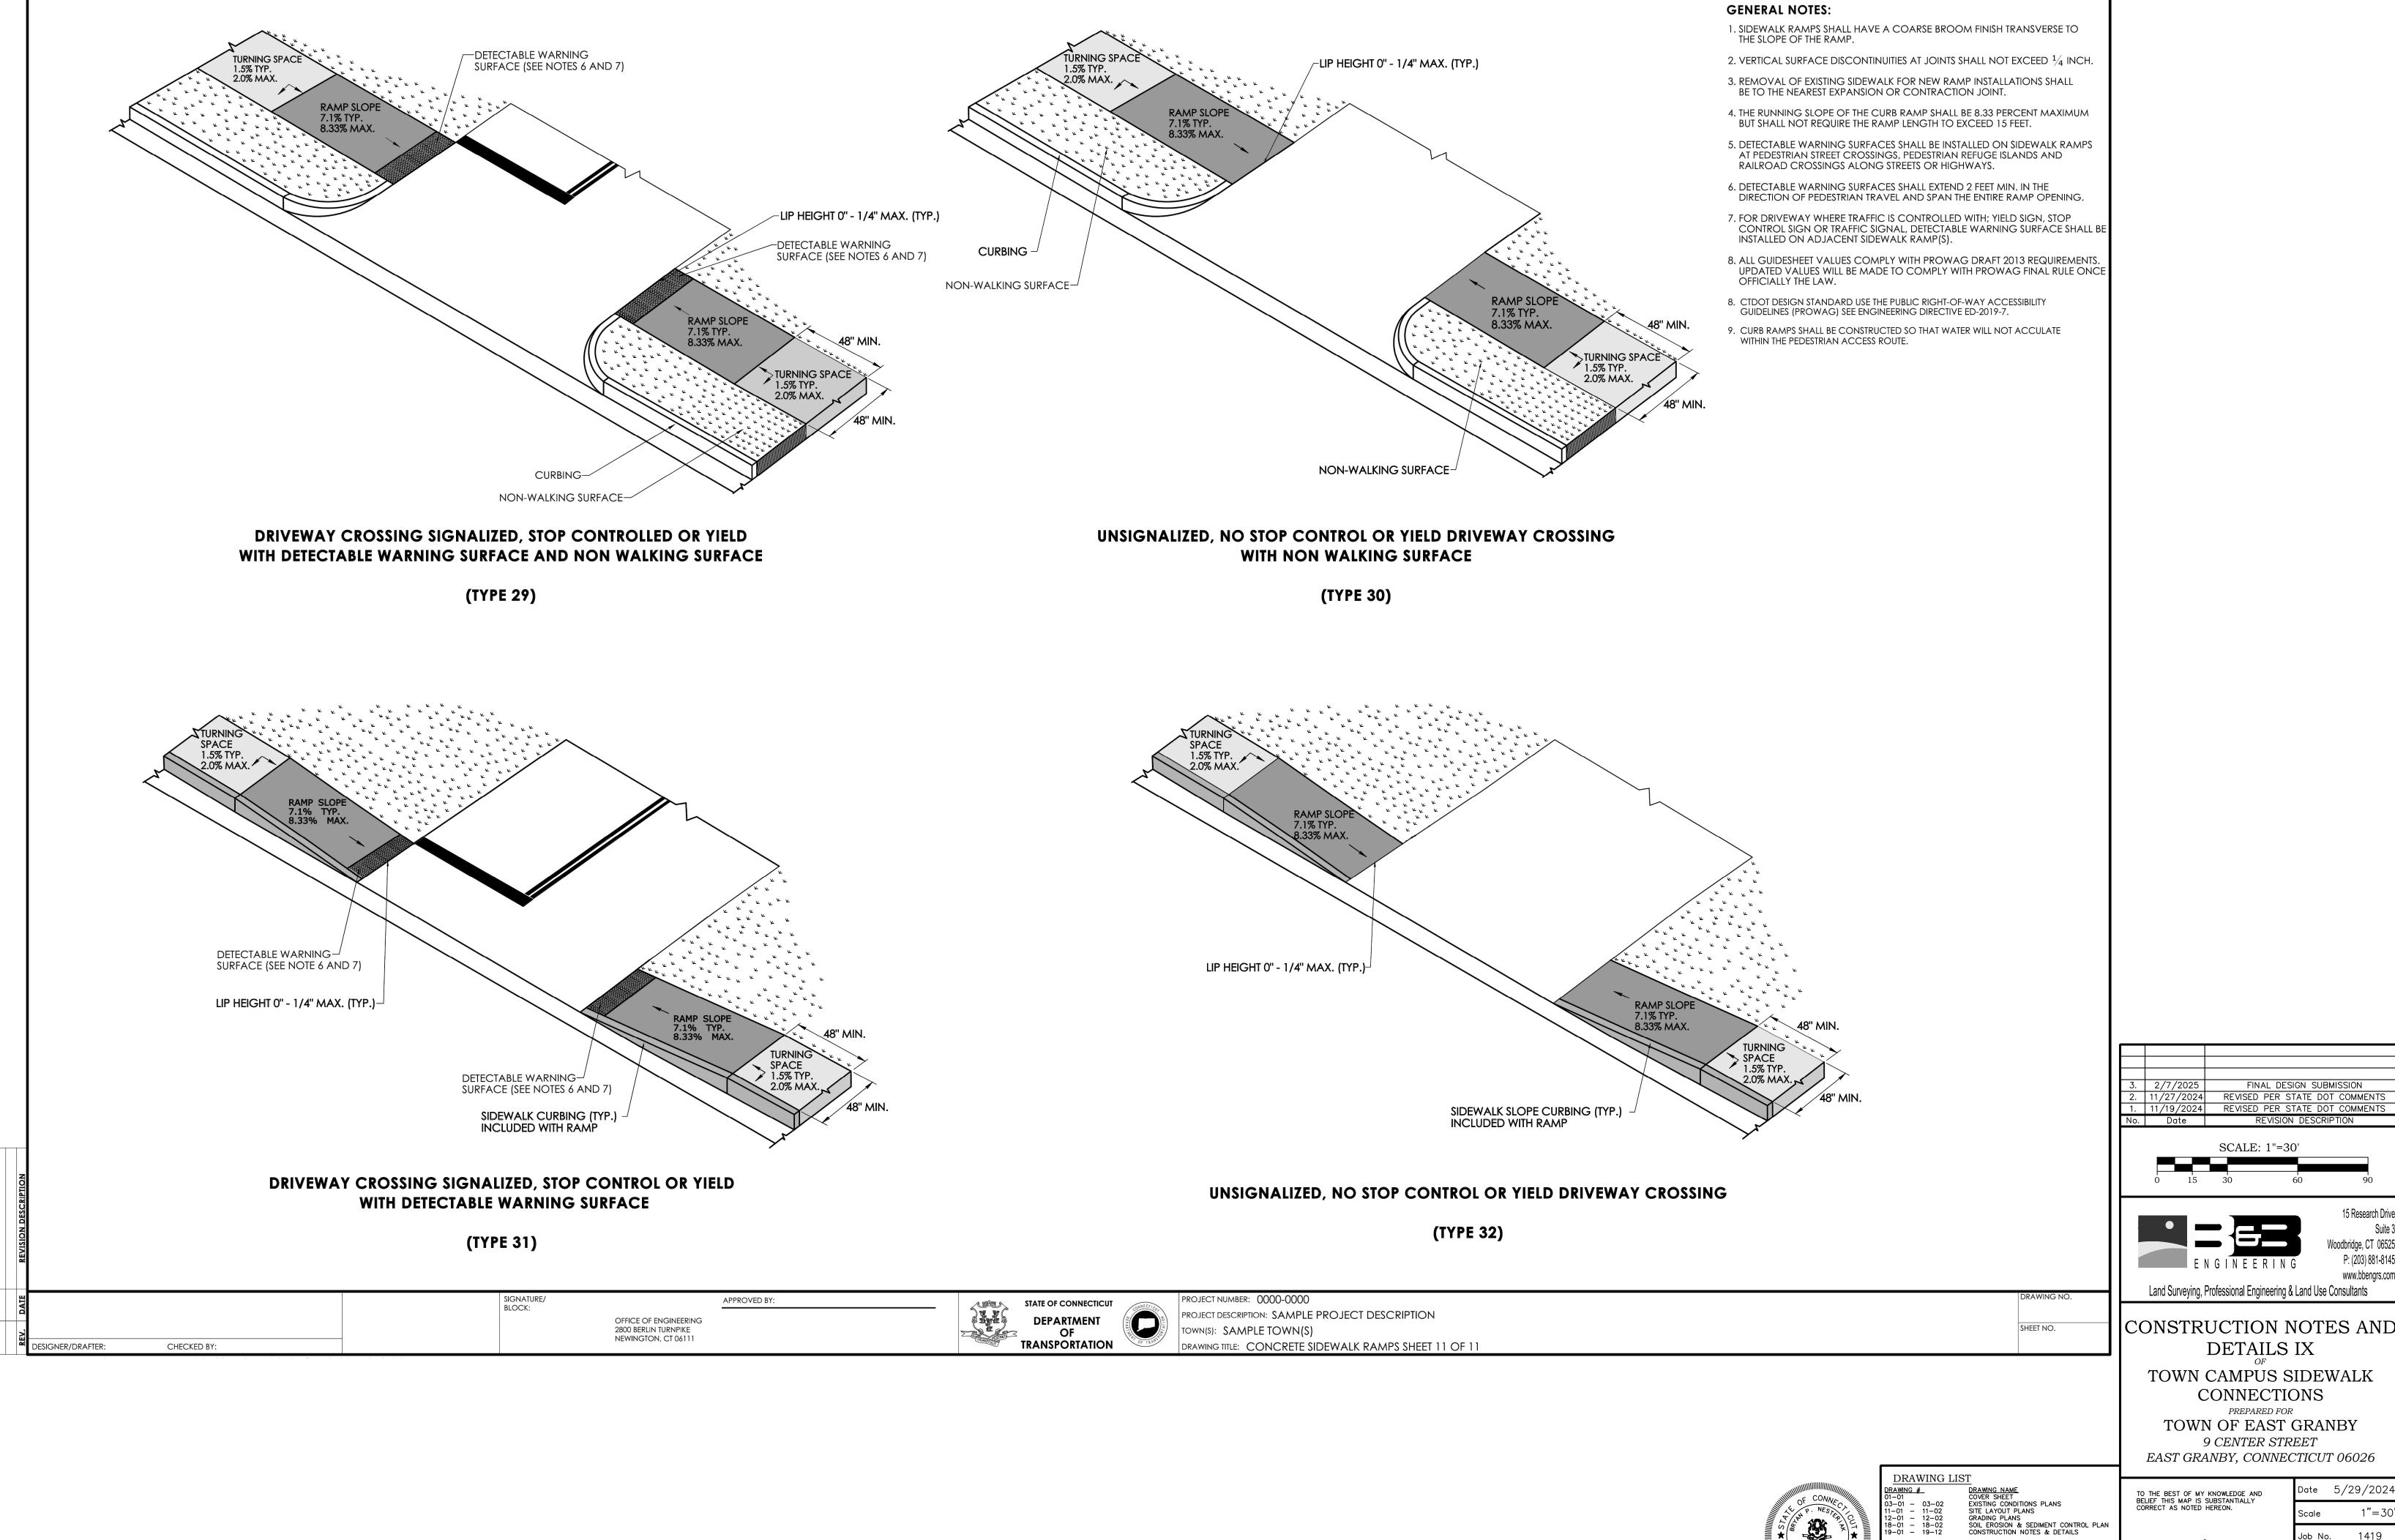
1"=30 Job No. 1419

FINAL DESIGN SUBMISSION

15 Research Drive

P: (203) 881-8145

Drawing No. 19-08

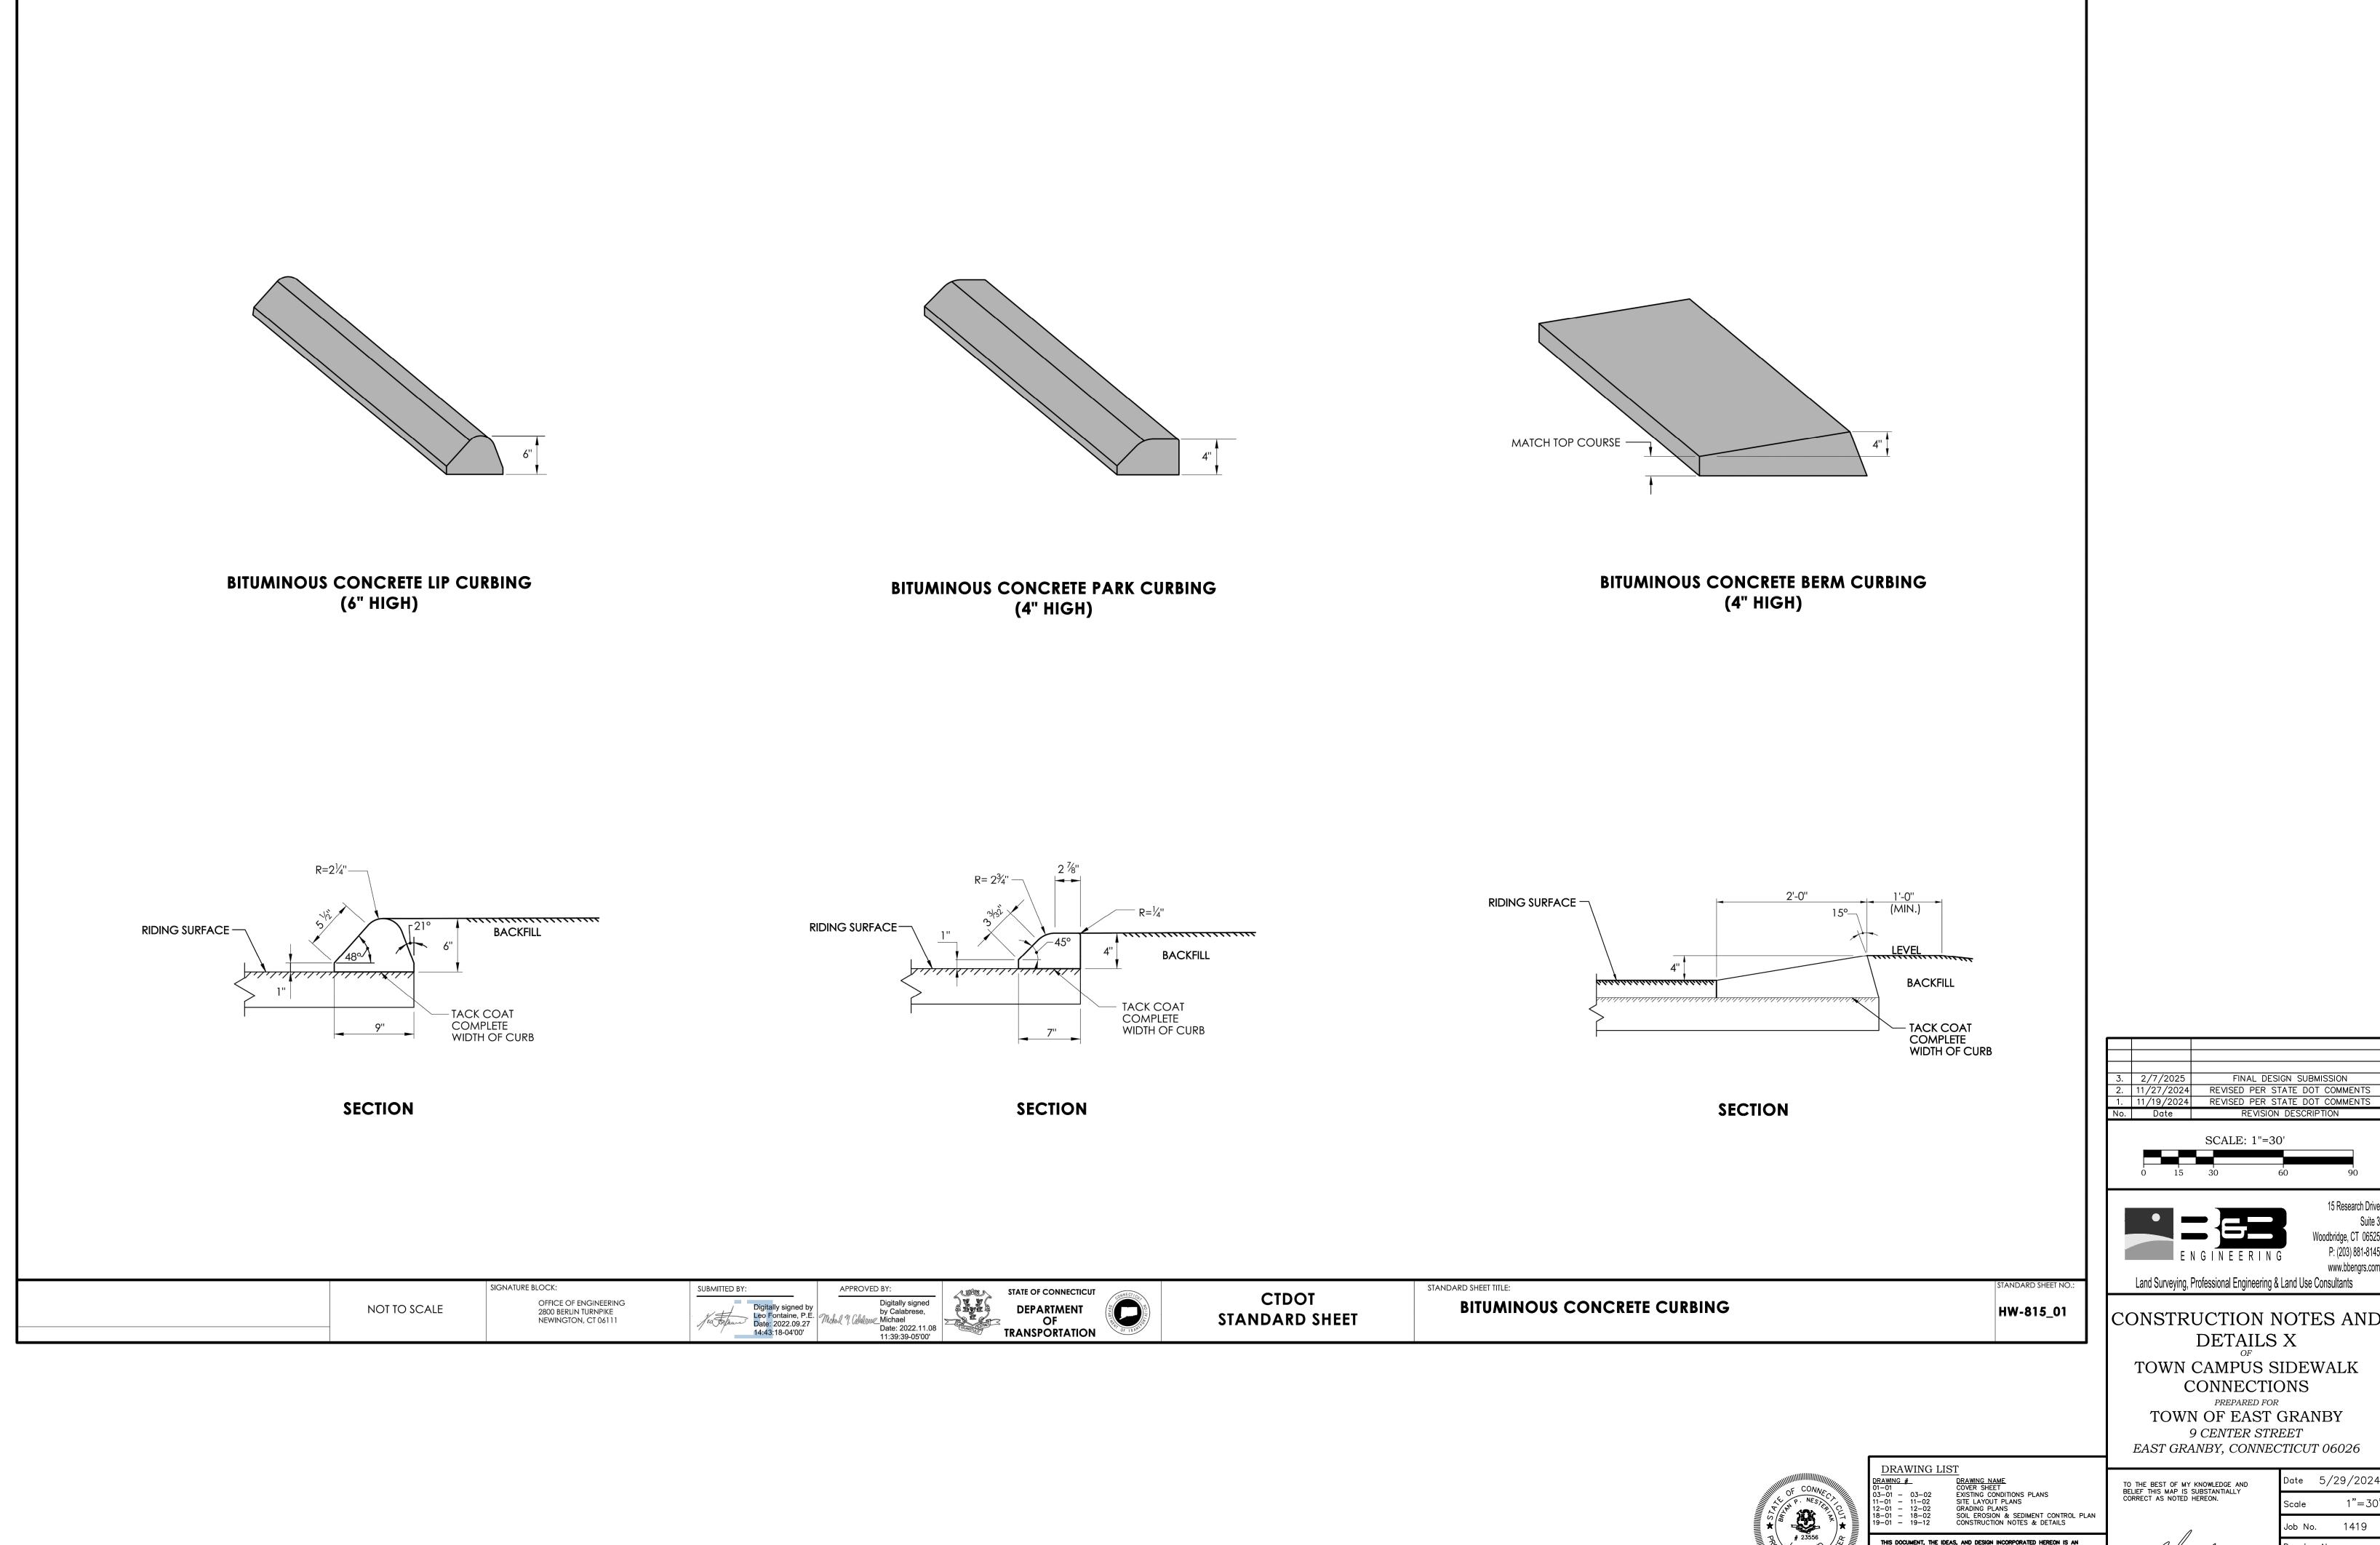




1"=30 1419 Drawing No. 19-09

15 Research Driv

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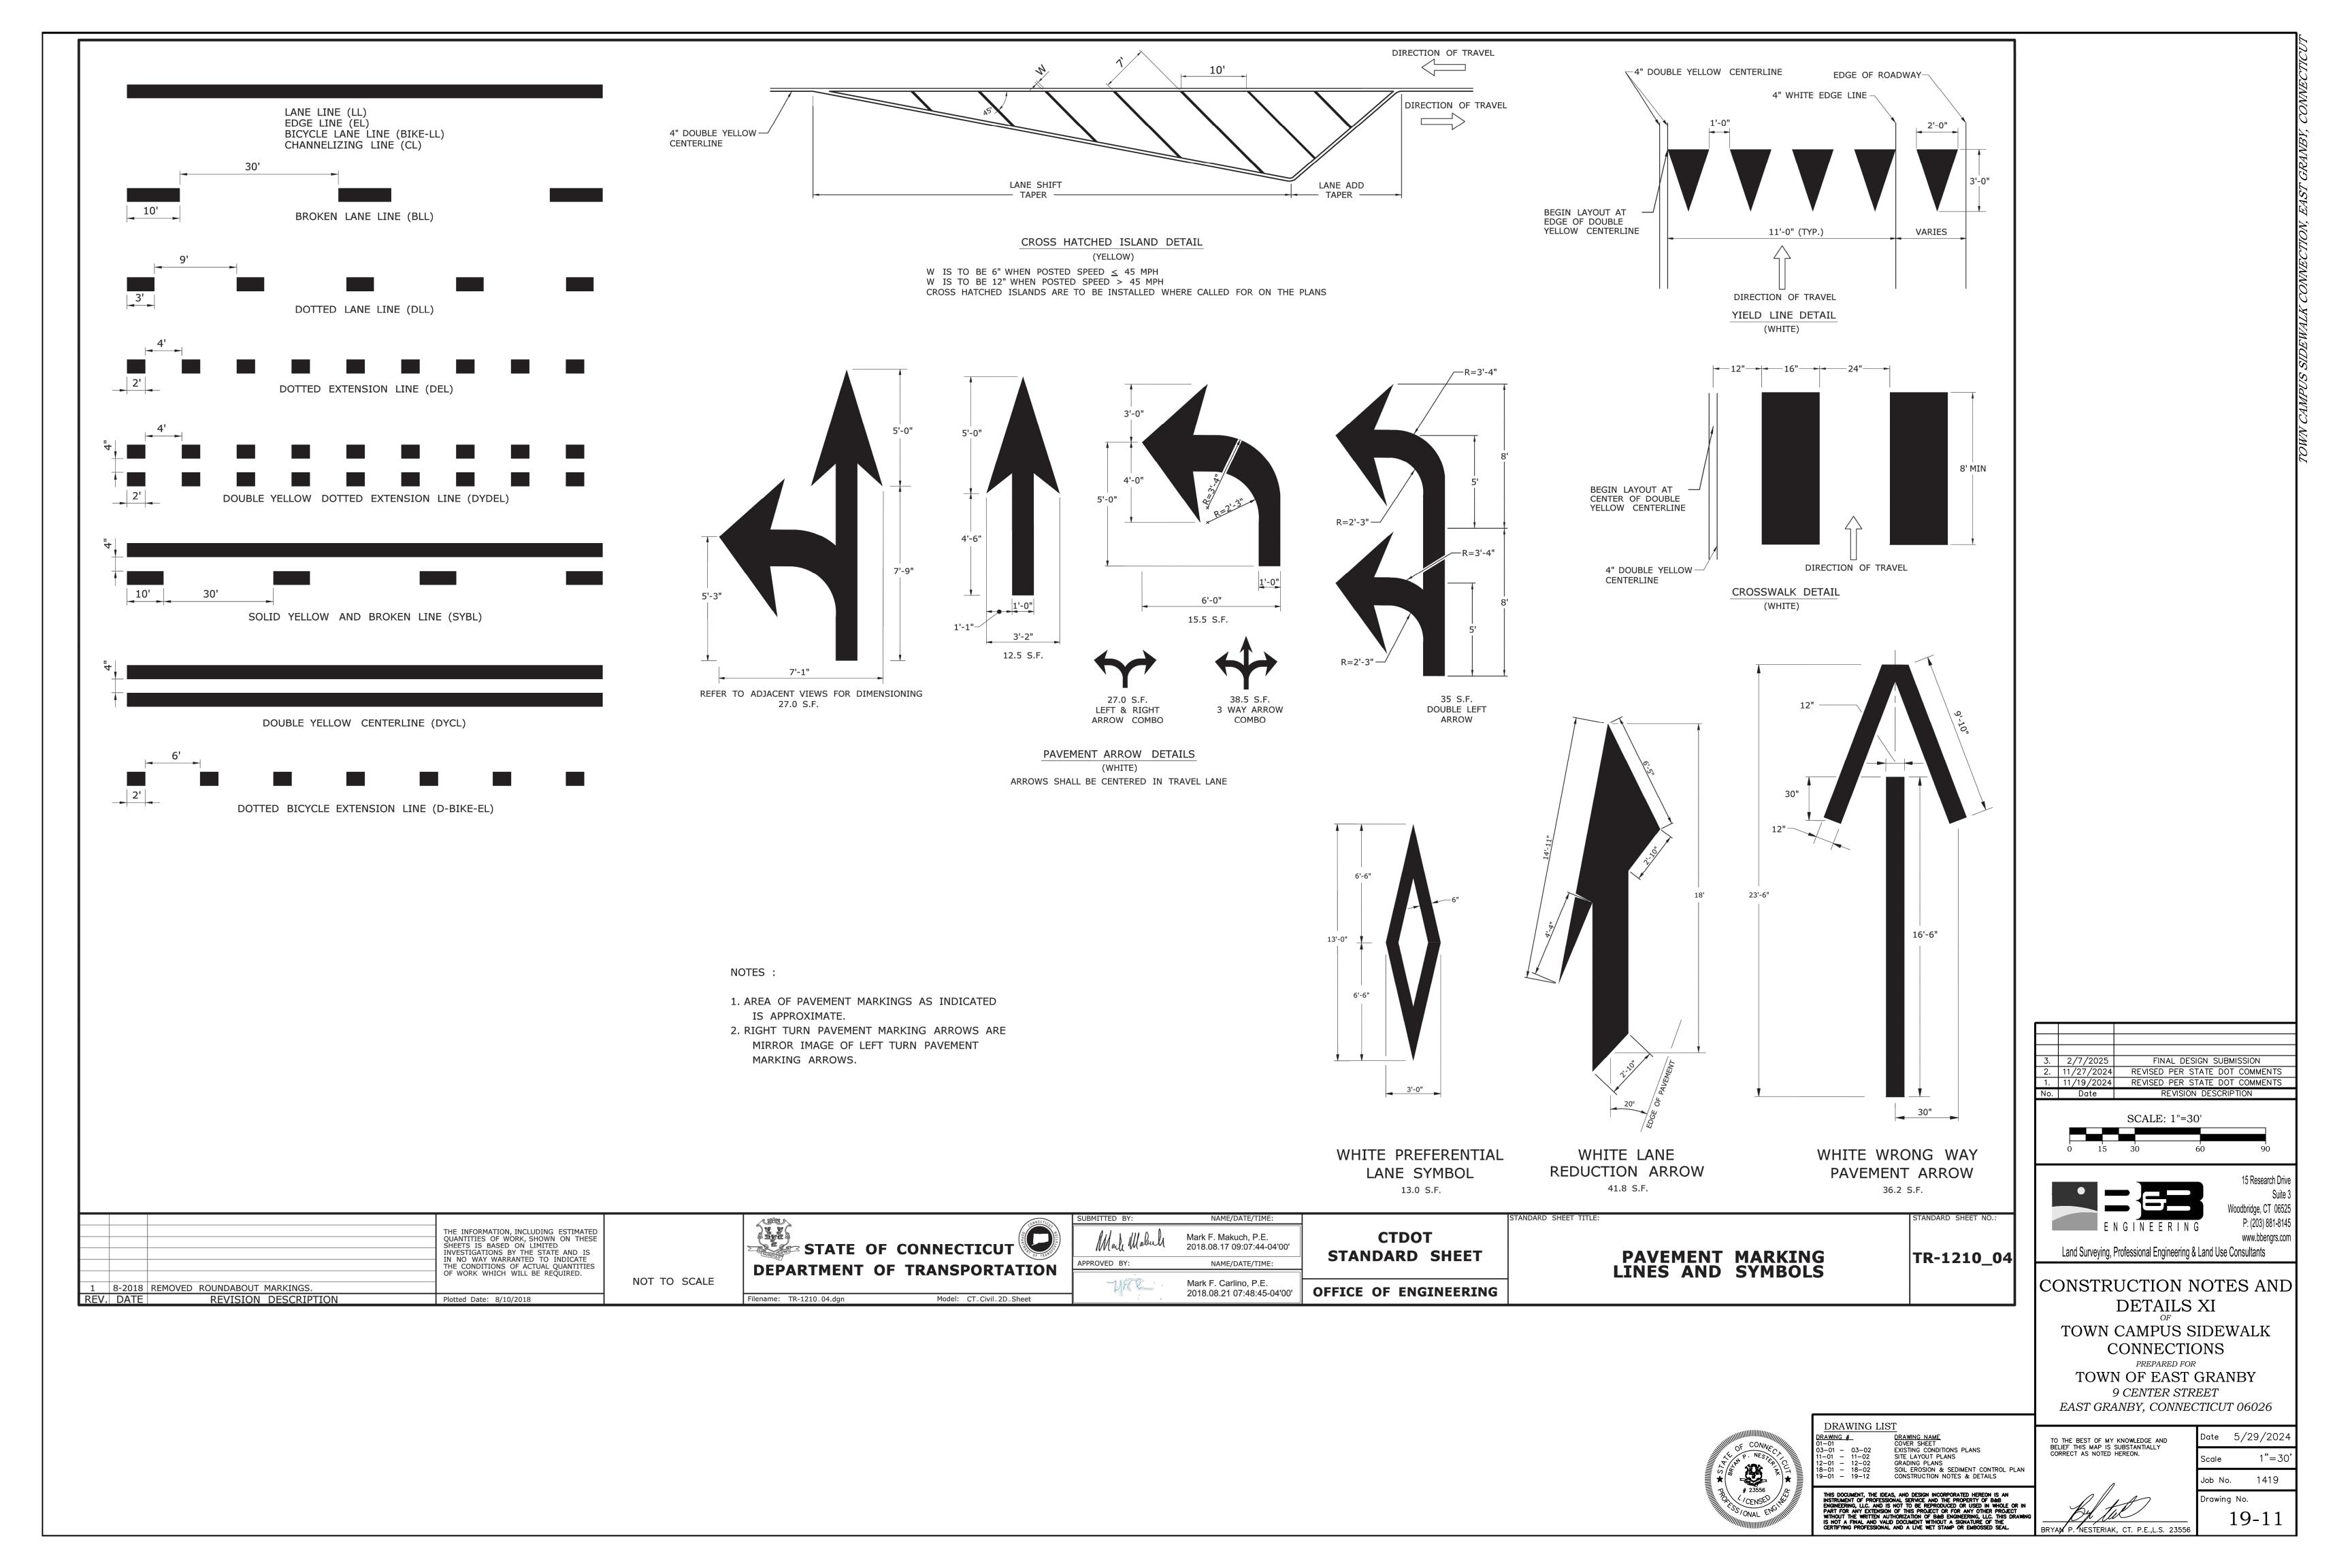


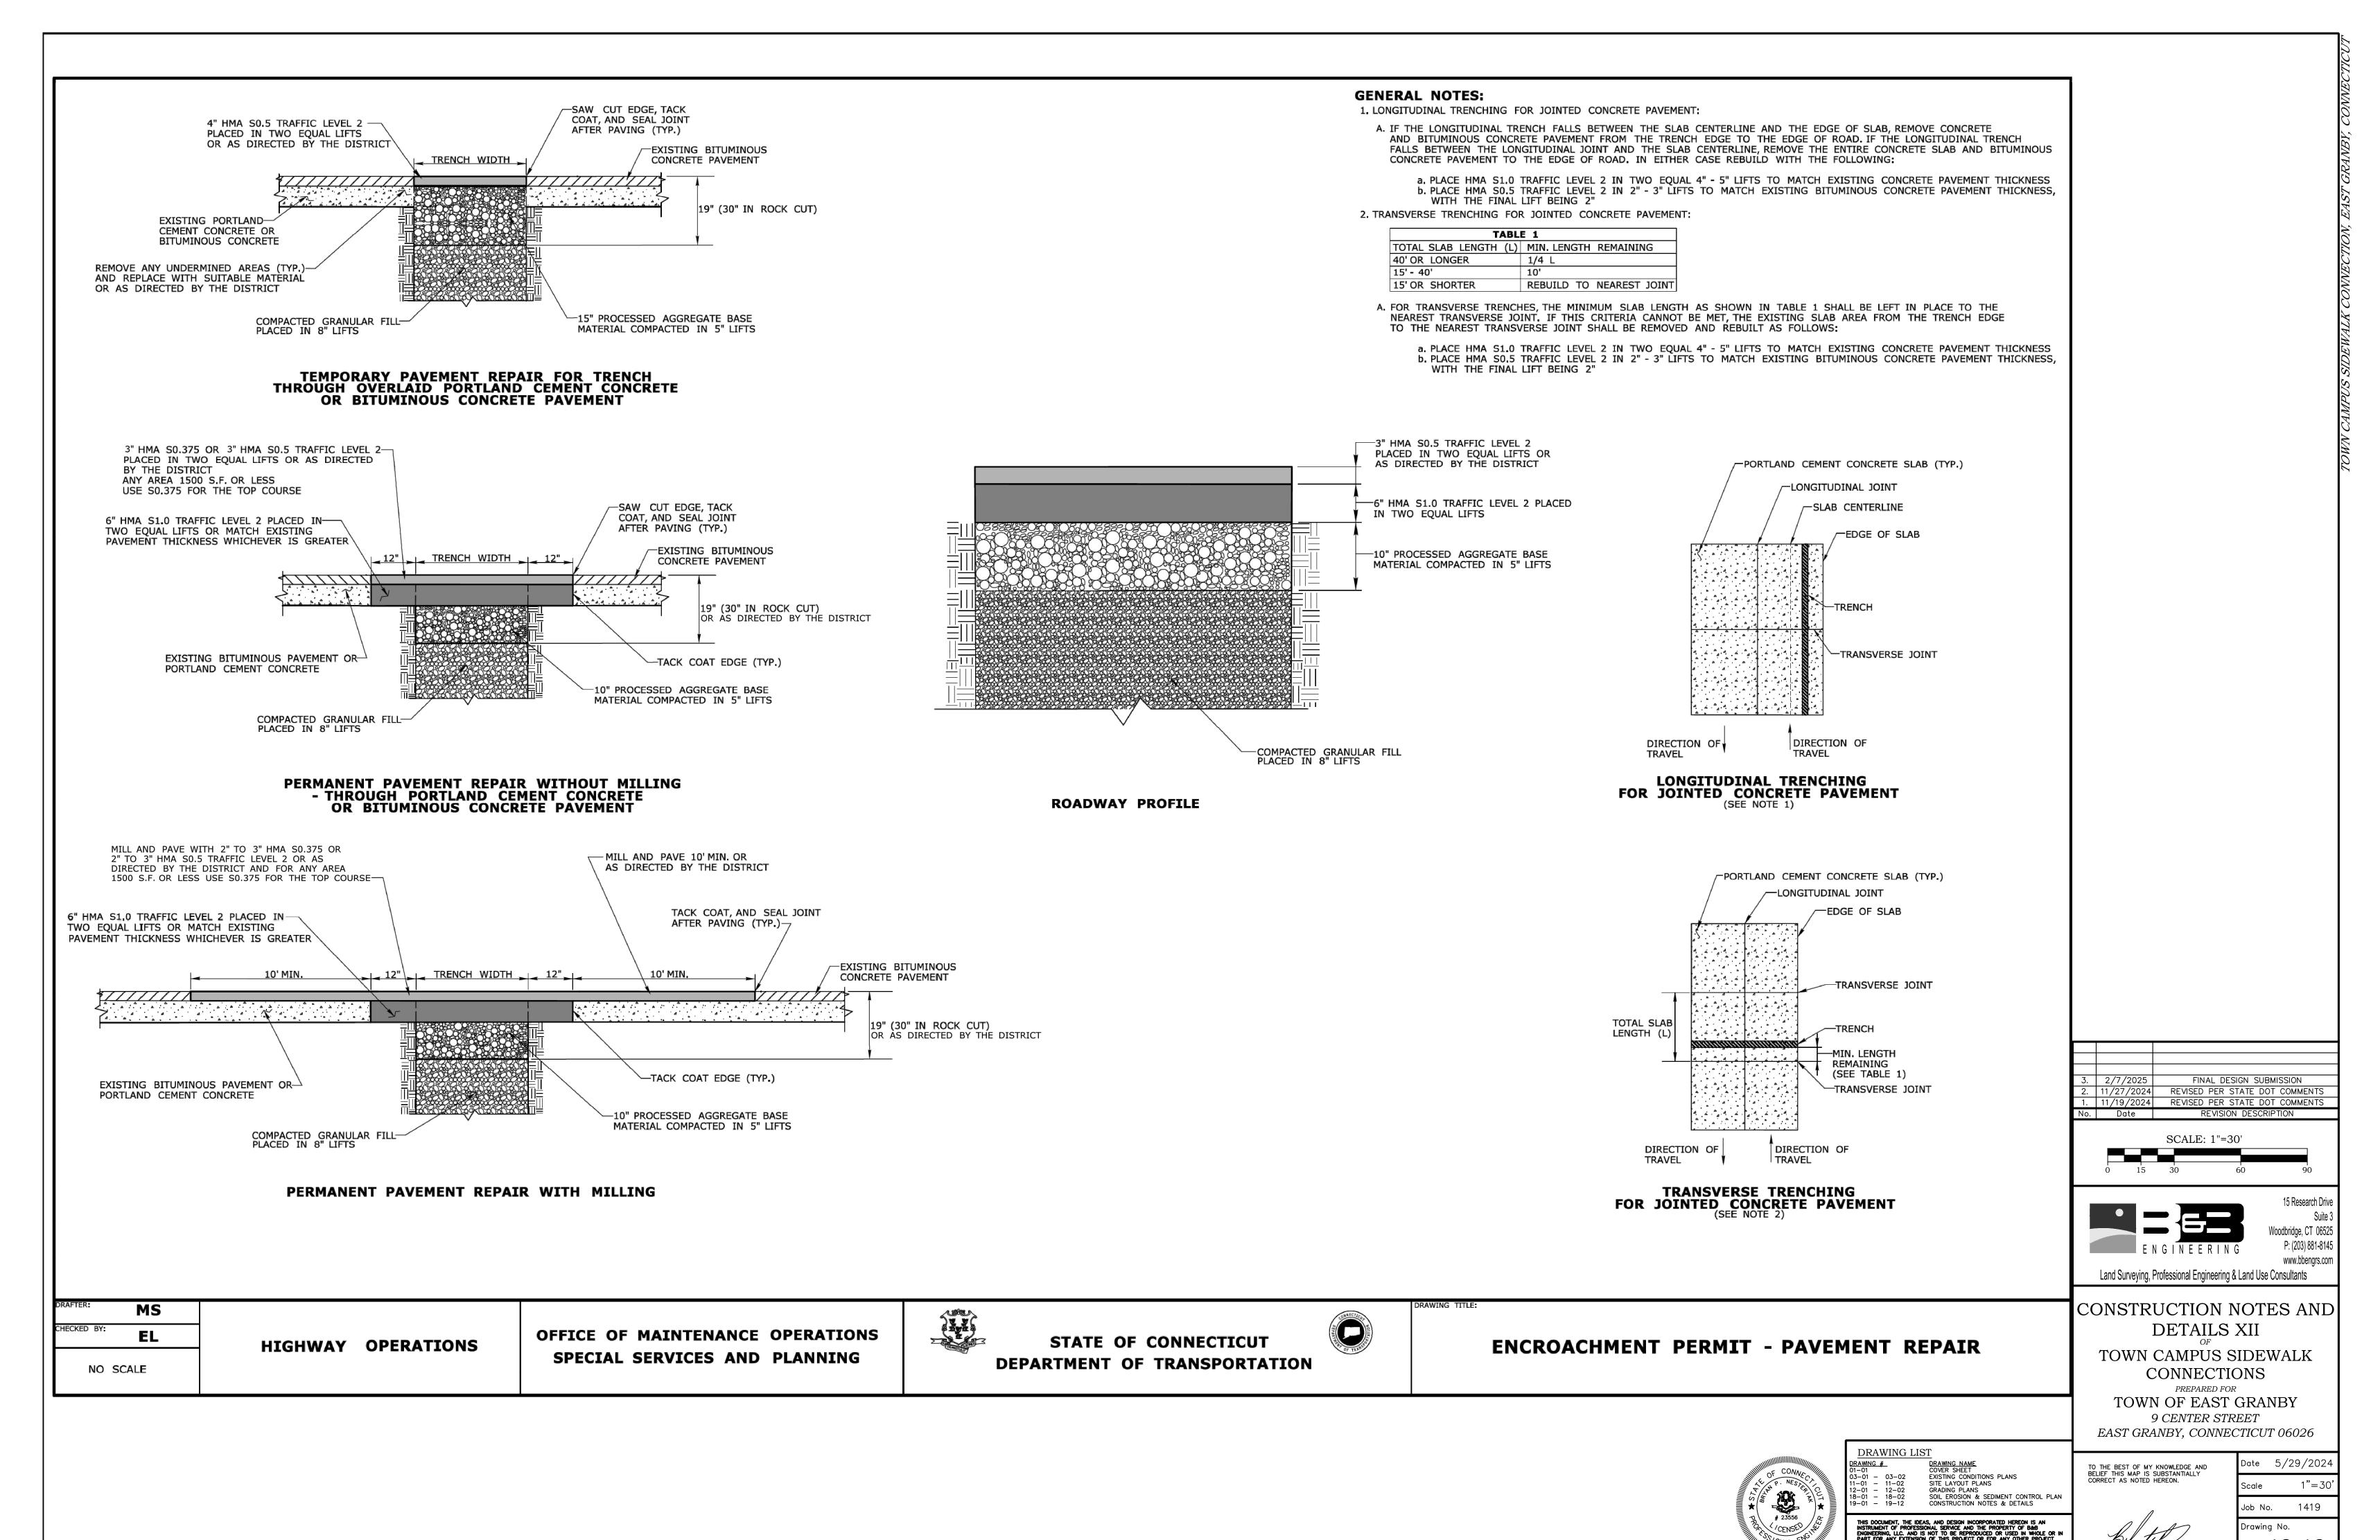
Job No. 1419 Drawing No. 19-10

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