


EAST GRANBY HIGH SCHOOL

Exterior Door Replacement

95 SOUTH MAIN STREET
EAST GRANBY, CT 06026

BID ISSUE - AUGUST 2, 2024 - PROJECT No. 2024.013

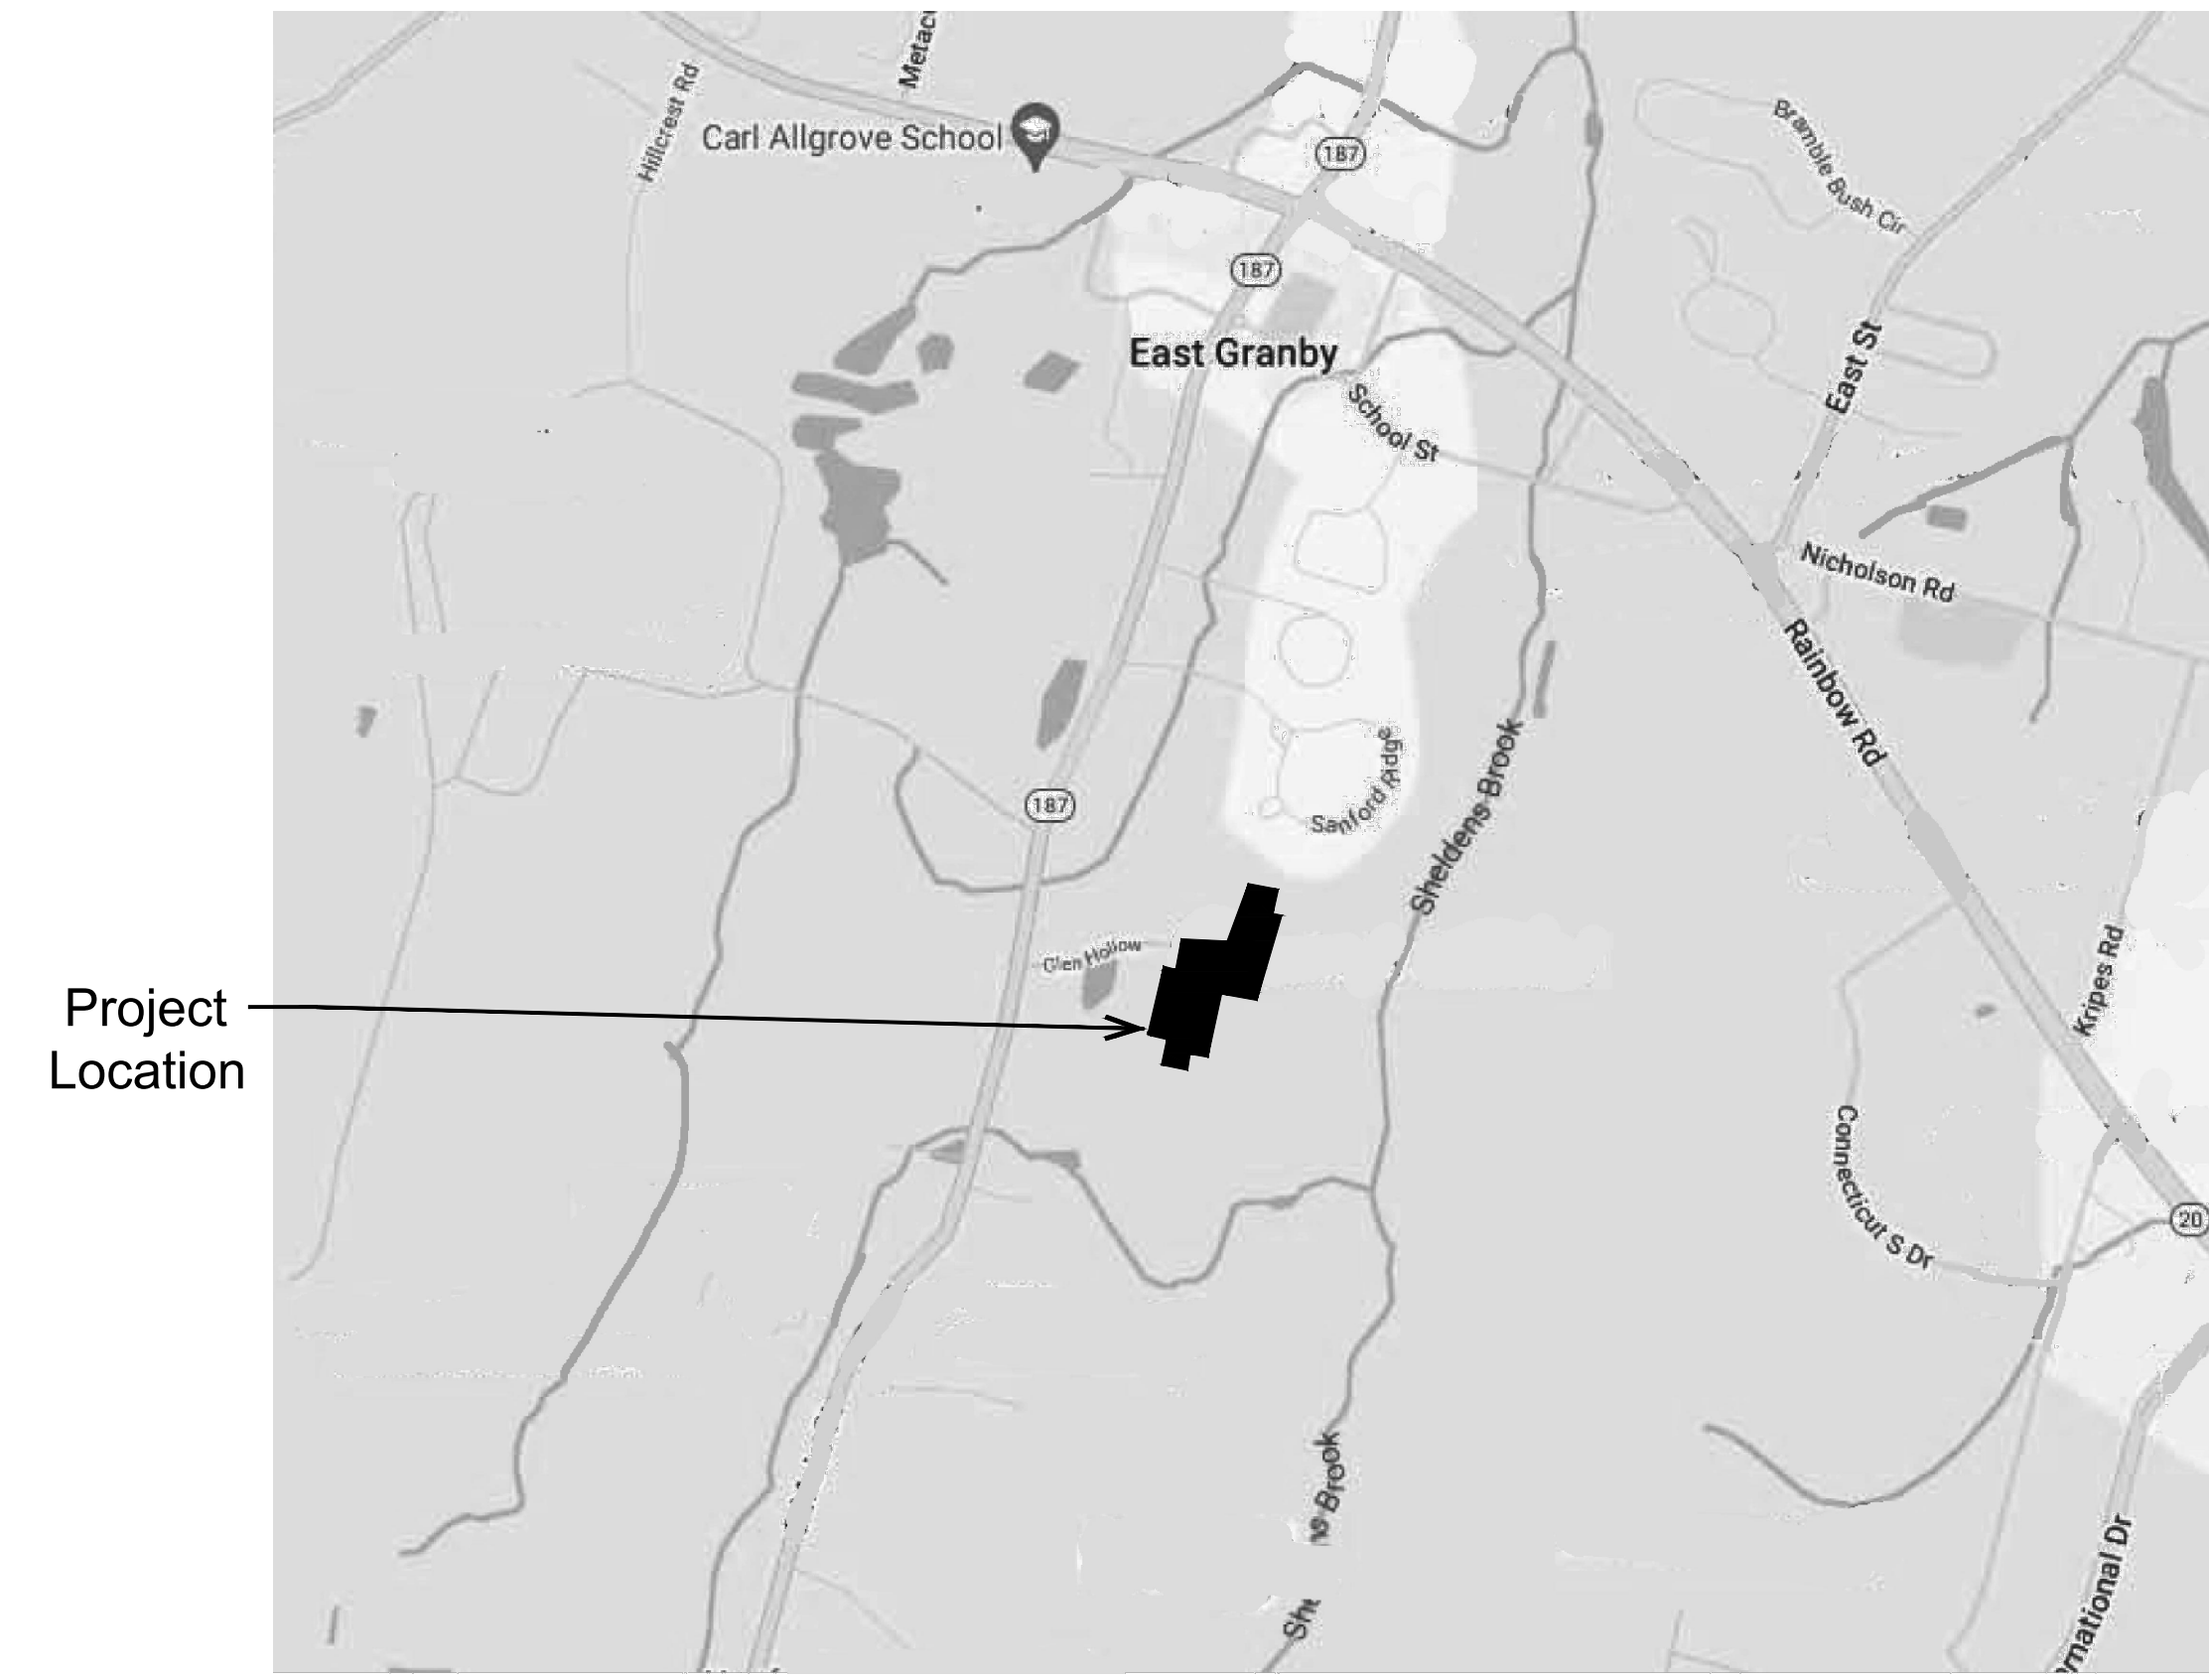


34 Sequassen Street, Hartford, CT 06106
Tel: 860.293.0093 / Fax: 860.293.0094

Architect

EAST GRANBY H.S. - Exterior Door Replacement

95 South Main Street
East Granby, CT 06026

BID ISSUE - August 2, 2024 - PROJECT No. 2023.013

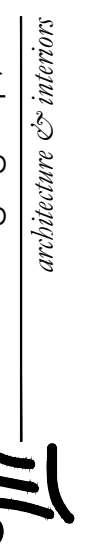


34 Sequassen Street, Hartford, CT 06106
Tel: 860.293.0093 / Fax: 860.293.0094

© 2024 Maier Design Group, llc. All Rights Reserved

ABBREVIATIONS

@	AT	GA.	GAUGE	REINF.	REINFORCING
A.B.	ANCHOR BOLT	GALV.	GALVANIZED	REQD.	REQUIRED
A/C	AIR CONDITIONING	G.B.	GRAB BAR	RESIL.	RESILIENT
AC.	ACOUSTICAL	G.C.	GENERAL CONTRACTOR	RET.	RETAINING
AC.T.	ACOUSTICAL TILE	GL.	GLASS	REV.	REVISION
ADJ.	ADJUSTABLE	GLZ.	GLAZING	R.O.	ROUGH OPENING
A.F.F.	ABOVE FINISHED FLOOR	GMU.	GLAZED MASONRY UNIT	R.O.W.	RIGHT OF WAY
AGGR.	AGGREGATE	GRD.	GROUND	R.T.	RUBBER TILE
A.H.U.	AIR HANDLING UNIT	GR.	GRADE	R.W.L.	RAIN WATER LEADER
ALT.	ALTERNATE	GWB	GYPSUM WALLBOARD	S. PFFG.	SPRAYED ON FIREPROOFING
ALUM.	ALUMINUM	H.B.	HOSE BIBB	S.C.	SOLID CORE
ANOD.	ANODIZED	HC	HANDICAPPED	SCH.	SCHEDULE
APPR.	APPROVED	H.C.	HOLLOW CORE	S.D.	SOAP DISPENSER
ASPH.	ASPHALT	HDWD.	HARDWOOD	SECT.	SECTION
BSMT.	BASEMENT	HDWE.	HARDWARE	S.F.	SQUARE FOOT
BD.	BOARD	HM.	HOLLOW METAL	SH.	SHelf
BEV.	BEVEL	HORIZ.	HORIZONTAL	SHWR.	SHOWER
B.F.	BOTTOM OF FOOTING	HTG.	HEATING	SHT.	SHEET
BITUM.	BITUMINOUS	HGT.	HEIGHT	SIM.	SIMILAR
BLDG.	BUILDING	HYD.	HYDRANT	SAN.	SANITARY
BLK.	BLOCK	I.D.	INSIDE DIAMETER	SAN.D.	SANITARY NAPKIN DISPENSER
BLKG.	BLOCKING	I.F.	INSIDE FACE	SPEC.	SPECIFICATIONS
BM.	BEAM	INCAND.	INCANDESCENT	SPKLR.	SPRINKLER
BOT.	BOTTOM	INCL.	INCLUDE	S.P.R.	SINGLE PLY ROOF
BRK.	BRICK	INFO.	INFORMATION	SQ.	SQUARE
B.U.R.	BUILT UP ROOFING	INSUL.	INSULATION	S.F.	SQUARE FEET
CAB.	CABINET	INT.	INTERIOR	S.S.	SERVICE SINK
C.B.	CATCH BASIN	INT.	INTERIOR	ST. STL.	STAINLESS STEEL
CEM.	CEMENT	INV.	INVERT	STA.	STATION
CER.	CERAMIC	I.P.S.	IRON PIPE SIZE	STD.	STANDARD
C.I.	CAST IRON	J.C.	JANITOR CLOSET	ST. FTG.	STEP FOOTING
C.J.	CONTROL JOINT	JST.	JOIST	STIFF.	STIFFENERS
CLG.	CEILING	JT.	JOINT	STL.	STEEL
CL.	CLOSET	LAD.	LADDER	STL. JST.	STEEL JOIST
C.M.U.	CONCRETE MASONRY UNIT	LAM.	LAMINATED	STOR.	STORAGE
C.O.	CLEAN OUT	LAV.	LAVATORY	S.T.C.	SOUND TRANSMISSION CLASS
COL.	COLUMN	LKR.	LOCKER	STRUCT.	STRUCTURAL
CONC.	CONCRETE	L.F.	LINEAR FOOT	SURF.	SURFACE
CONF.	CONFERENCE	LL.	LIVE LOAD	SUSP.	SUSPEND
CONT.	CONTINUOUS	LT.	LIGHT	S. & V.	STAIN & VARNISH
COORD.	COORDINATE	MAINT.	MAINTENANCE	SYM.	SYMMETRICAL
CORR.	CORRIDOR, CORRUGATED	MAS.	MASONRY	SYS.	SYSTEM
CPT.	CARPET	MATL.	MATERIAL	TR.	TREAD
CTR.	CENTER	MECH.	MECHANICAL	T & B	TOP & BOTTOM
C.Y.	CUBIC YARD	MEMB.	MEMBRANE	T. BD.	TACKBOARD
DEPT.	DEPARTMENT	MET.	METAL	TB.	TOWEL BAR
DETL.	DETAIL	MEZZ.	MEZZANINE	TECH.	TECHNICAL
D.F.	DRINKING FOUNTAIN	MFR.	MANUFACTURER	T / C	TOP OF CURB
DIA.	DIAMETER	MIN.	MINIMUM	TEL.	TELEPHONE
DIM.	DIMENSION	MIR.	MIRROR	TEMP.	TEMPORARY
DN.	DOWN	MISC.	MISCELLANEOUS	TERR.	TERRAZZO
DR.	DOOR	M.O.	MASONRY OPENING	T / FOUND.	TOP OF FOUNDATION
DS.	DOWNSPOUT	MTD.	MOUNTED	T & G	TONGUE & GROOVE
D.S.P.	DRY STANDPIPE	M.U.	MASONRY UNIT	THK.	THICK
DWG.	DRAWING	MULL.	MULLION	THRES.	THRESHOLD
DWL.	DOWEL	N.	NORTH	TILT.	TILE
EA.	EACH	N.I.C.	NOT IN CONTRACT	T.P.	TOILET PAPER DISPENSER
E.J.	EXPANSION JOINT	NO. #	NUMBER	T / PR.	TOP OF PIER
EL.	ELEVATION	NOM.	NOMINAL	T / S	TOP OF SLAB
ELEC.	ELECTRIC	N.R.C.	NOISE REDUCTION COEFFICIENT	T / SHLF	TOP OF SHELF
ELEV.	ELEVATOR	N.T.S.	NOT TO SCALE	T / STL.	TOP OF STEEL
EMERG.	EMERGENCY	O.A.	OUTSIDE AIR	T / CONC.	TOP OF CONCRETE
ENCL.	ENCLOSURE	O.C.	ON CENTER	T.V.	TELEVISION
E.P.	ELECTRICAL PANEL	O.D.	OUTSIDE DIAMETER	TYP.	TYPICAL
EQ.	EQUAL, EQUIVALENT	OFF.	OFFICE	U.H.	UNIT HEATER
EQUIP.	EQUIPMENT	OH.D.	OVERHEAD	U.L.	UNDERWRITERS LABORATORY
E.W.	EACH WAY	OPG.	OPENING	UNFIN.	UNFINISHED
E.W.C.	ELECTRIC WATER COOLER	OPP.	OPPOSITE	U.O.N.	UNLESS OTHERWISE NOTED
EXP.	EXPANSION	OZ	OUNCE	UR.	URINAL
EXT.	EXTERIOR	PRTN.	PARTITION	U.V.	UNIT VENTILATOR
F.A.	FIRE ALARM	PL.	PLATE	VB.	VINYL BASE
F.A.P.	FIRE ALARM PANEL	P.L.	PLASTIC LAMINATE	V.C.T.	VINYL COMPOSITION TILE
F.BRK.	FACE BRICK	PLAS.	PLASTER	VERT.	VERTICAL
F.F.	FINISH FLOOR	PLYWD.	PLYWOOD	VEST.	VESTIBULE
F.D.	FLOOR DRAIN	PR.	PAIR	V.G.	VERTICAL GRAIN
FDN.	FOUNDATION	PREFAB.	PREFABRICATED	V.I.F.	VERIFY IN FIELD
F.E.	FIRE EXTINGUISHER	PROJ.	PROJECT	VOL.	VOLUME
F.E.C.	FIRE EXTINGUISHER CABINET	PROP.	PROPERTY	V.W.C.	VINYL WALL COVERING
F.H.	FIRE HYDRANT	PTD.	PAINTED	W /	WITH
F.H.C.	FIRE HOSE CABINET	P.T.D.	PAPER TOWEL DISPENSER	W.C.	VINYL WALL COVERING
FIN.	FINISHED	Q.T.	QUARRY TILE	WD.	WOOD
FL.	FLOOR	R.	RADIUS	WIND.	WINDOW
FLX.	FLEXIBLE	R.A.	RETURN AIR	W / O	WITHOUT
FLASH.	FLASHING	RESIL.	RESILIENT	WP.	WATERPROOFING
FLEX.	FLEXIBLE	RECPT.	RECEPTACLE	W. PT.	WORKING POINT
FLUOR.	FLUORESCENT	REF.	REFERENCE	W.L.	WORKING LINE
F.O.C.	FACE OF CONCRETE	REFL.	REFLECTED	W.S.	WALL SLEEVE
F.O.M.	FACE OF MASONRY	REFR.	REFRIGERATOR	WAINS.	WAINSCOT
F.PRFG.	FIREPROOFING	REG.	REGISTER	WT.	WEIGHT
F.R.	FIRE RETARDANT TREATED	REG.	REGISTER	WWF.	WELDED WIRE FABRIC
FT.	FEET			YD.	YARD
F.T.R.	FINNED TUBE RADIATION				
FURR.	FURRING				

ACCESSIBILITY

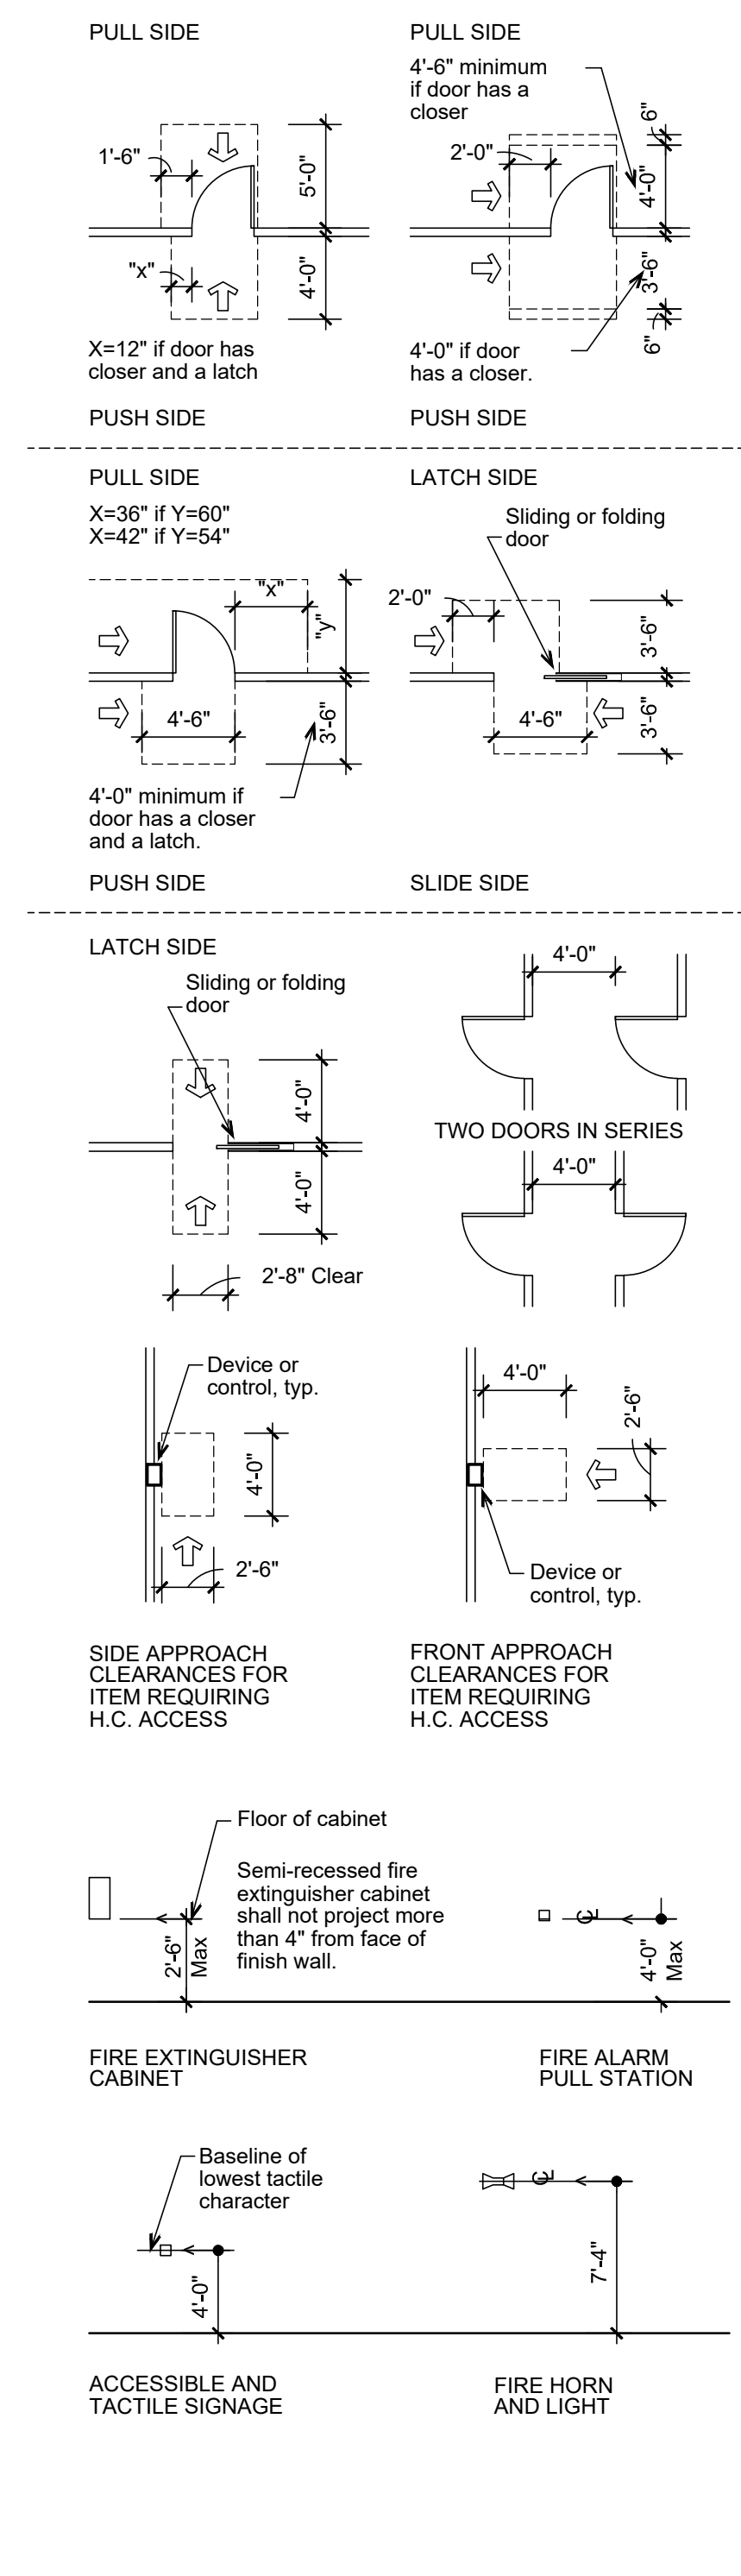

LIST OF DRAWINGS

Sheet	Title	Revision	Status
G000	Title Sheet	△	08/02/2024 Issued
G001	General Information	△	08/02/2024 Issued
A100	Master Building Location Plan	△	08/02/2024 Issued
A101	Area One Floor Plan	△	08/02/2024 Issued
A102	Area Two Floor Plan	△	08/02/2024 Issued
A103	Area Three Floor Plan	△	08/02/2024 Issued
A200	Door Schedule and Elevations	△	08/02/2024 Issued
A201	Details	△	08/02/2024 Issued

CODE INFORMATION

GENERAL
 Governing Codes: Connecticut State Building Code
 (2021 IBC with 2022 CT Supplement)
 2021 International Existing Building Code (IEBC),
 2021 CT State Fire Safety Code,
 ICC/ANSI A117.1-2017.

Code Review based on 2021 IBC.
 Existing Use: E Education.

NO CHANGE OF USE.

Type of Construction: Existing Type IIB, Non-Combustible/Unprotected.

NOTE:
 Project is deemed as a 'REPAIR' under Chapter 4 of the IEBC
 *Replacement of building elements in kind, maintaining the established and current means of egress

East Granby High School
Exterior Door Replacement
 95 SOUTH MAIN STREET
 EAST GRANBY, CT 06026

MAIER design group, llc.
 architecture & interiors

34 Sequassen Street, Hartford, CT 06106
 Tel: 860.293.0093 / Fax: 860.293.0094

GENERAL INFORMATION SHEET


Project Number:	Issue Date:
2024.013	Aug. 2, 2024
Scale:	CAD File:
AS NOTED	24013_G001
Drawn By:	Checked By:
map	EAL

Revisions:

G001



Aerial Site View

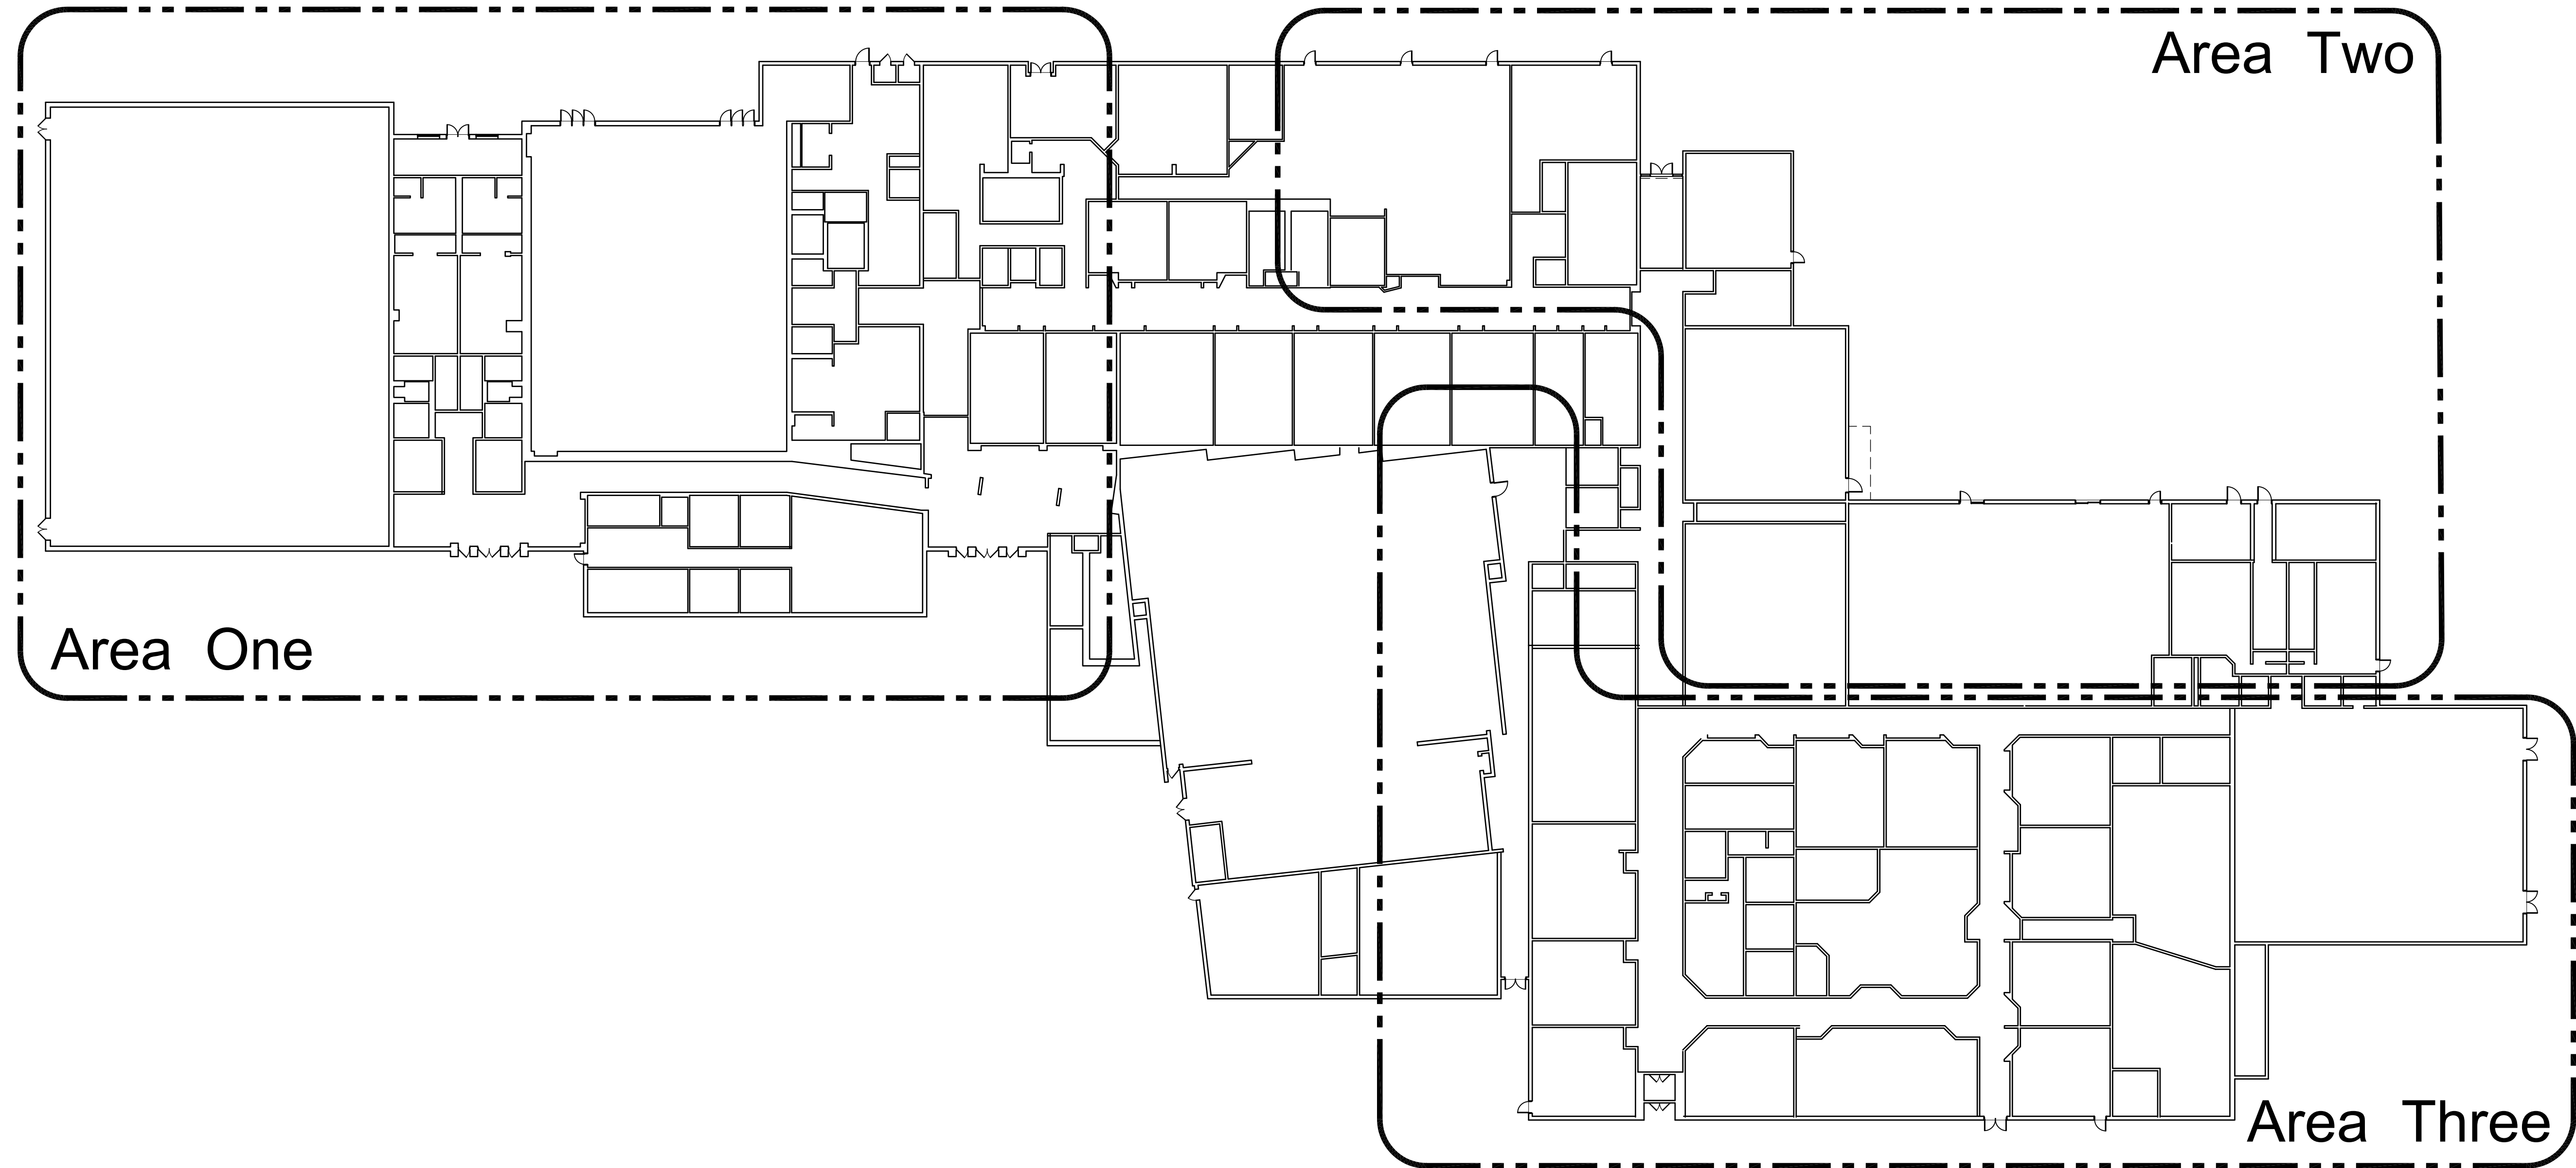

East Granby High School
Exterior Door Replacement
95 SOUTH MAIN STREET
EAST GRANBY, CT 06026

MAIER design group, llc.
architecture & interiors

34 Sequassen Street, Hartford, CT 06106
Tel: 860.293.0093 / Fax: 860.293.0094


MASTER BUILDING
LOCATION PLAN

Project Number: 2024.013	Issue Date: Aug 2, 2024
Scale: AS NOTED	CAD File: 24013_A100
Drawn By: map	Checked By: EAL

Revisions:

← A100

LEGEND			
	Existing door and frame to remain shown thus, typical.		Detail No. Interior Elevation Flag
	New door, frame and wall shown thus, typical.		Door No. Door Opening Tag, refer to Door Schedule for further information
	Existing partition to remain, patch and repair as necessary to prepare surface for new finishes scheduled.		Frame Tag, refer to Door and Frame Schedule for further information.
	Selective portions of existing construction to be removed or modified shown thus, typical.		Numbered note tag
	Wall Type Indicator		Denotes dimension from face of framing to face of framing or face of existing finished surface unless specifically noted otherwise.
	Denotes dimension between two centerlines.		Spot elevation indicated thus. Dimensions in parenthesis are negative numbers.

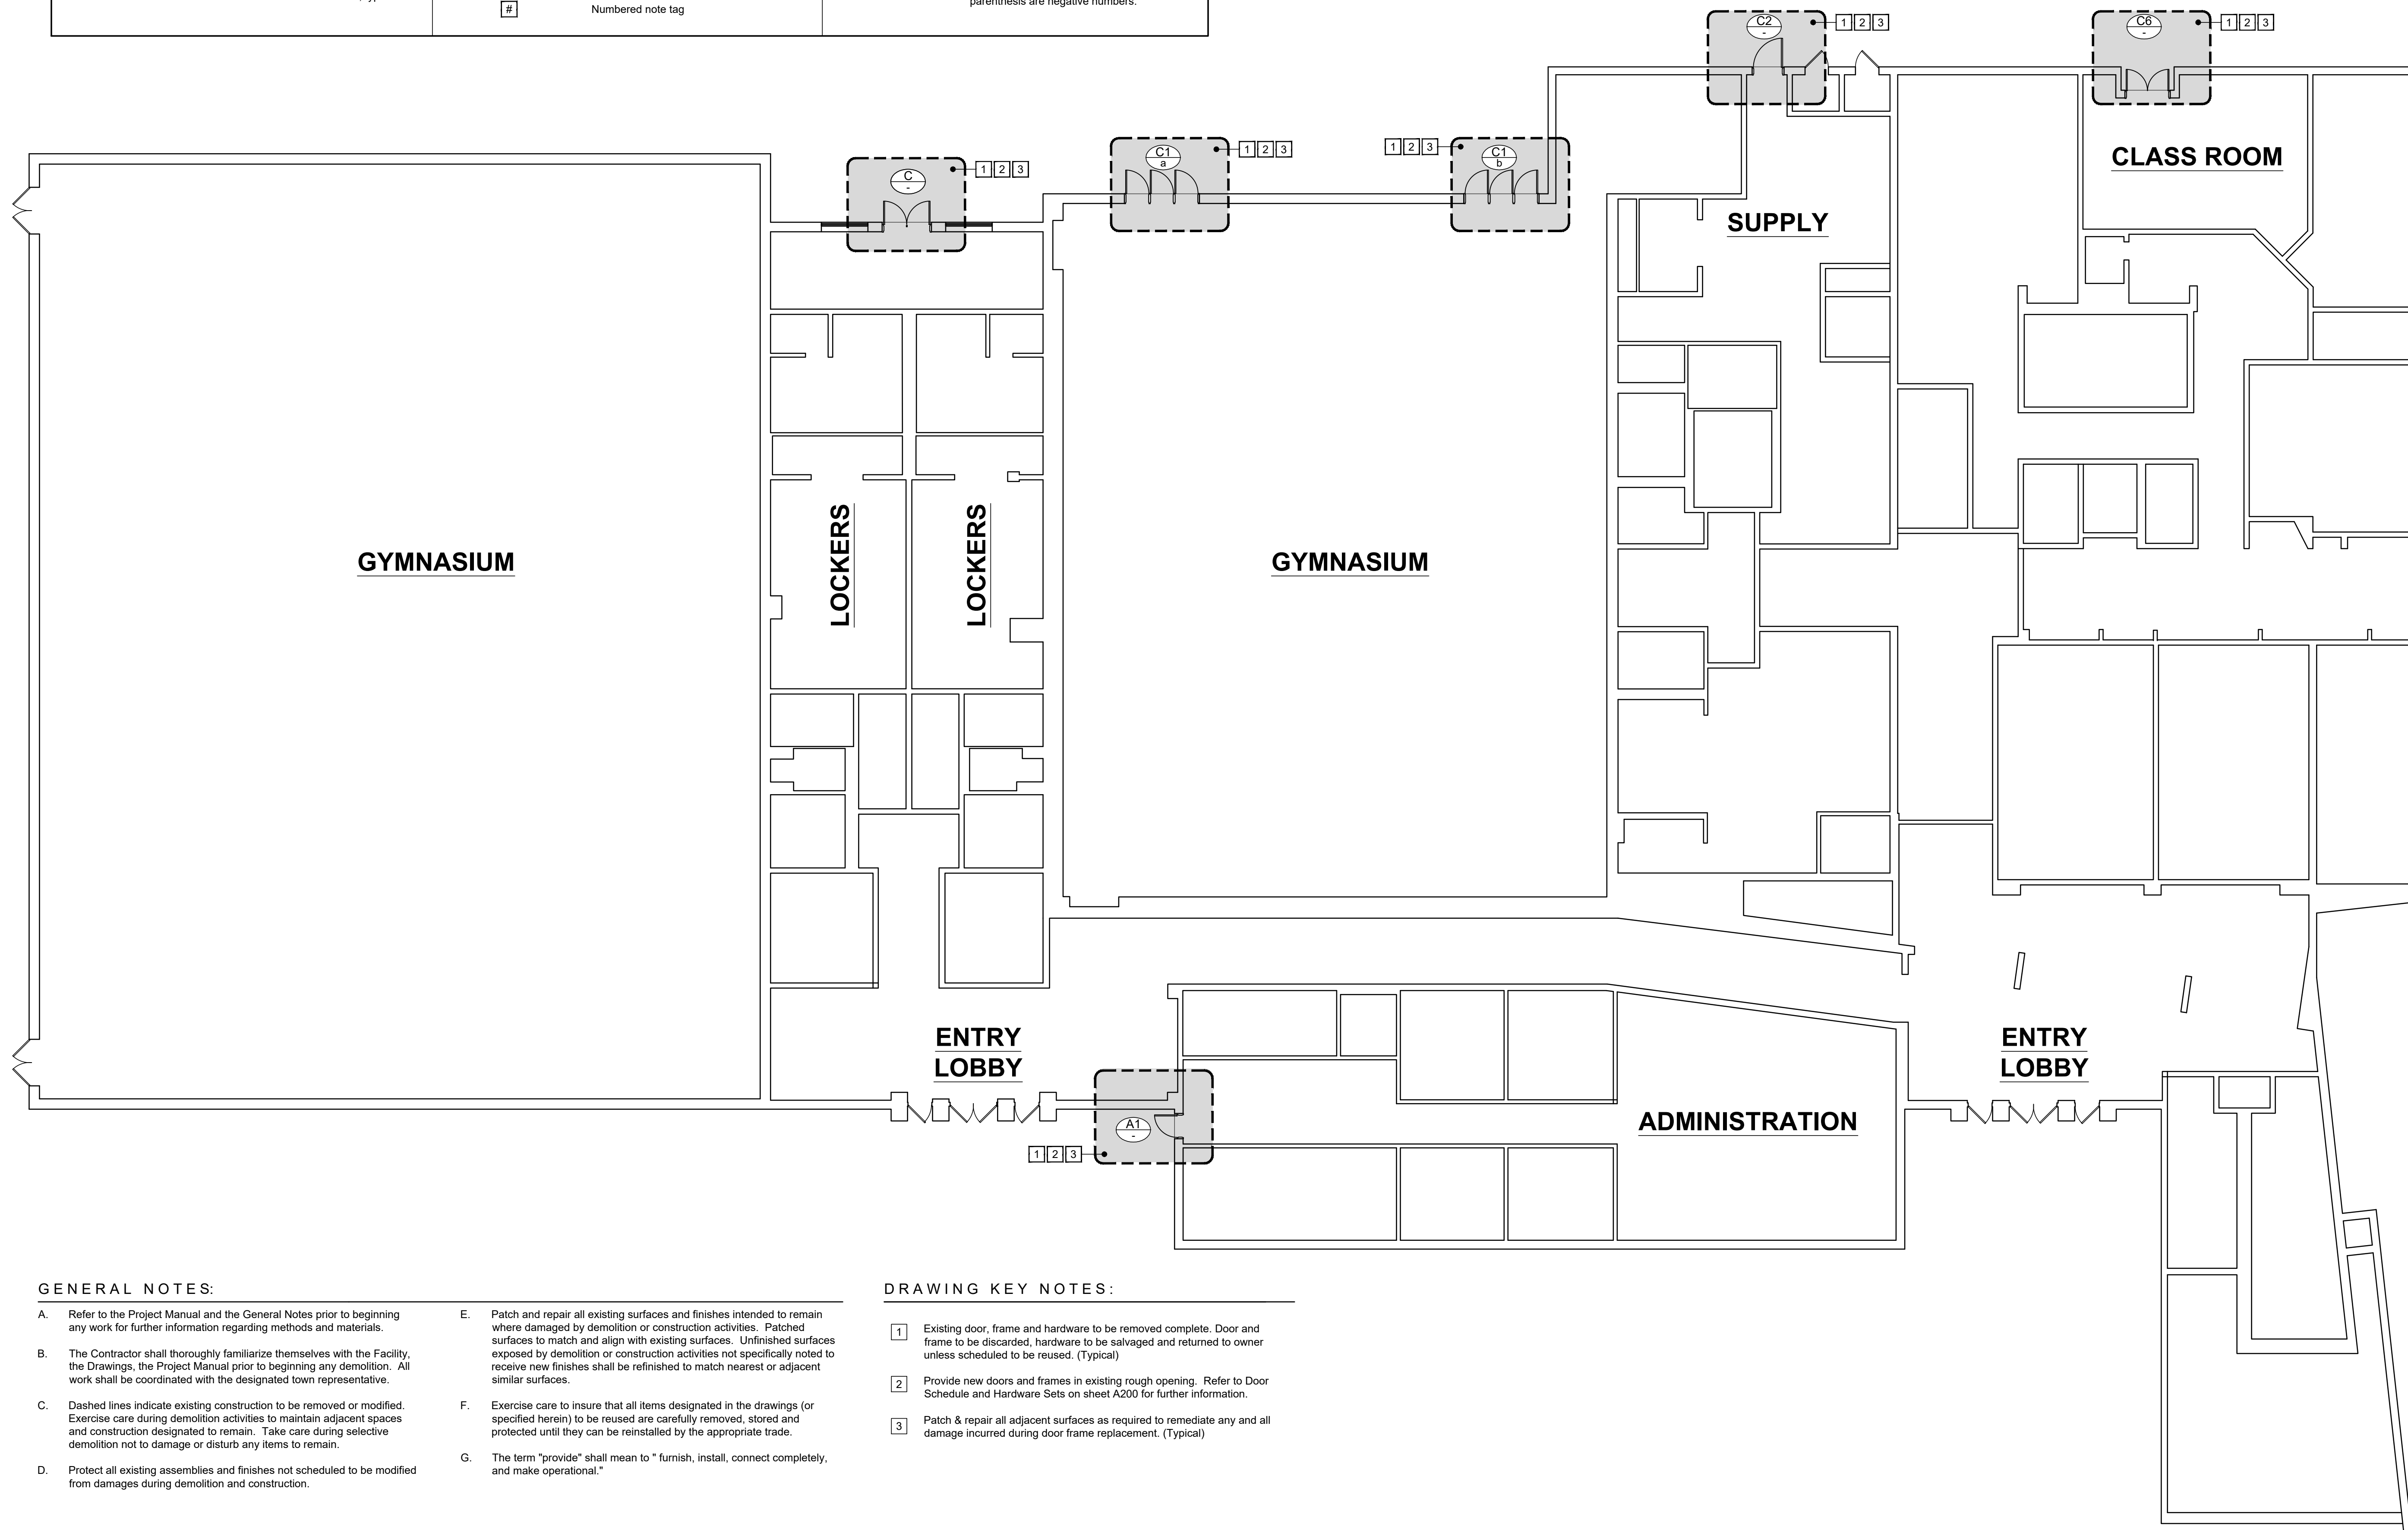


GENERAL NOTES:

- A. Refer to the Project Manual and the General Notes prior to beginning any work for further information regarding methods and materials.
- B. The Contractor shall thoroughly familiarize themselves with the Facility, the Drawings, the Project Manual prior to beginning any demolition. All work shall be coordinated with the designated town representative.
- C. Dashed lines indicate existing construction to be removed or modified. Exercise care during demolition activities to maintain adjacent spaces and construction designated to remain. Take care during selective demolition not to damage or disturb any items to remain.
- D. Protect all existing assemblies and finishes not scheduled to be modified from damages during demolition and construction.
- E. Patch and repair all existing surfaces and finishes intended to remain where damaged by demolition or construction activities. Patched surfaces to match and align with existing surfaces. Unfinished surfaces exposed by demolition or construction activities not specifically noted to receive new finishes shall be refinished to match nearest or adjacent similar surfaces.
- F. Exercise care to insure that all items designated in the drawings (or specified herein) to be reused are carefully removed, stored and protected until they can be reinstalled by the appropriate trade.
- G. The term "provide" shall mean to "furnish, install, connect completely, and make operational."

DRAWING KEY NOTES:

- 1 Existing door, frame and hardware to be removed complete. Door and frame to be discarded, hardware to be salvaged and returned to owner unless scheduled to be reused. (Typical)
- 2 Provide new doors and frames in existing rough opening. Refer to Door Schedule and Hardware Sets on sheet A200 for further information.
- 3 Patch & repair all adjacent surfaces as required to remediate any and all damage incurred during door frame replacement. (Typical)

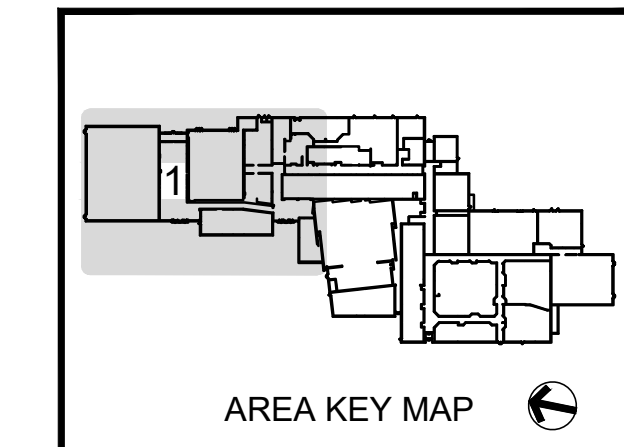

East Granby High School
Exterior Door Replacement
95 SOUTH MAIN STREET
EAST GRANBY, CT 06026

MAIER design group, llc.
architecture & interiors
34 Sequassen Street, Hartford, CT 06106
Tel: 860.293.0093 / Fax: 860.293.0094

**AREA ONE
PARTIAL PLAN**

Project Number: 2024.013 Issue Date: Aug. 2, 2024
Scale: AS NOTED CAD File: 24013_A101
Drawn By: mmp Checked By: EAL


Revisions:

GENERAL NOTES:


- A. Refer to the Project Manual and the General Notes prior to beginning any work for further information regarding methods and materials.
- B. The Contractor shall thoroughly familiarize themselves with the Facility, the Drawings, the Project Manual prior to beginning any demolition. All work shall be coordinated with the designated town representative.
- C. Dashed lines indicate existing construction to be removed or modified. Exercise care during demolition activities to maintain adjacent spaces and construction designated to remain. Take care during selective demolition not to damage or disturb any items to remain.
- D. Protect all existing assemblies and finishes not scheduled to be modified from damages during demolition and construction.
- E. Patch and repair all existing surfaces and finishes intended to remain where damaged by demolition or construction activities. Patched surfaces to match and align with existing surfaces. Unfinished surfaces exposed by demolition or construction activities not specifically noted to receive new finishes shall be refinished to match nearest or adjacent similar surfaces.
- F. Exercise care to insure that all items designated in the drawings (or specified herein) to be reused are carefully removed, stored and protected until they can be reinstalled by the appropriate trade.
- G. The term "provide" shall mean to "furnish, install, connect completely, and make operational."

DRAWING KEY NOTES:

- 1 Existing door, frame and hardware to be removed complete. Door and frame to be discarded, hardware to be salvaged and returned to owner unless scheduled to be reused. (Typical)
- 2 Provide new doors and frames in existing rough opening. Refer to Door Schedule and Hardware Sets on sheet A200 for further information.
- 3 Patch & repair all adjacent surfaces as required to remediate any and all damage incurred during door frame replacement. (Typical)
- 4 Remove existing hollow metal glazing system complete for entire 2 floor high stairwell atrium.
- 5 Entire glazing & framing system to be removed by others.

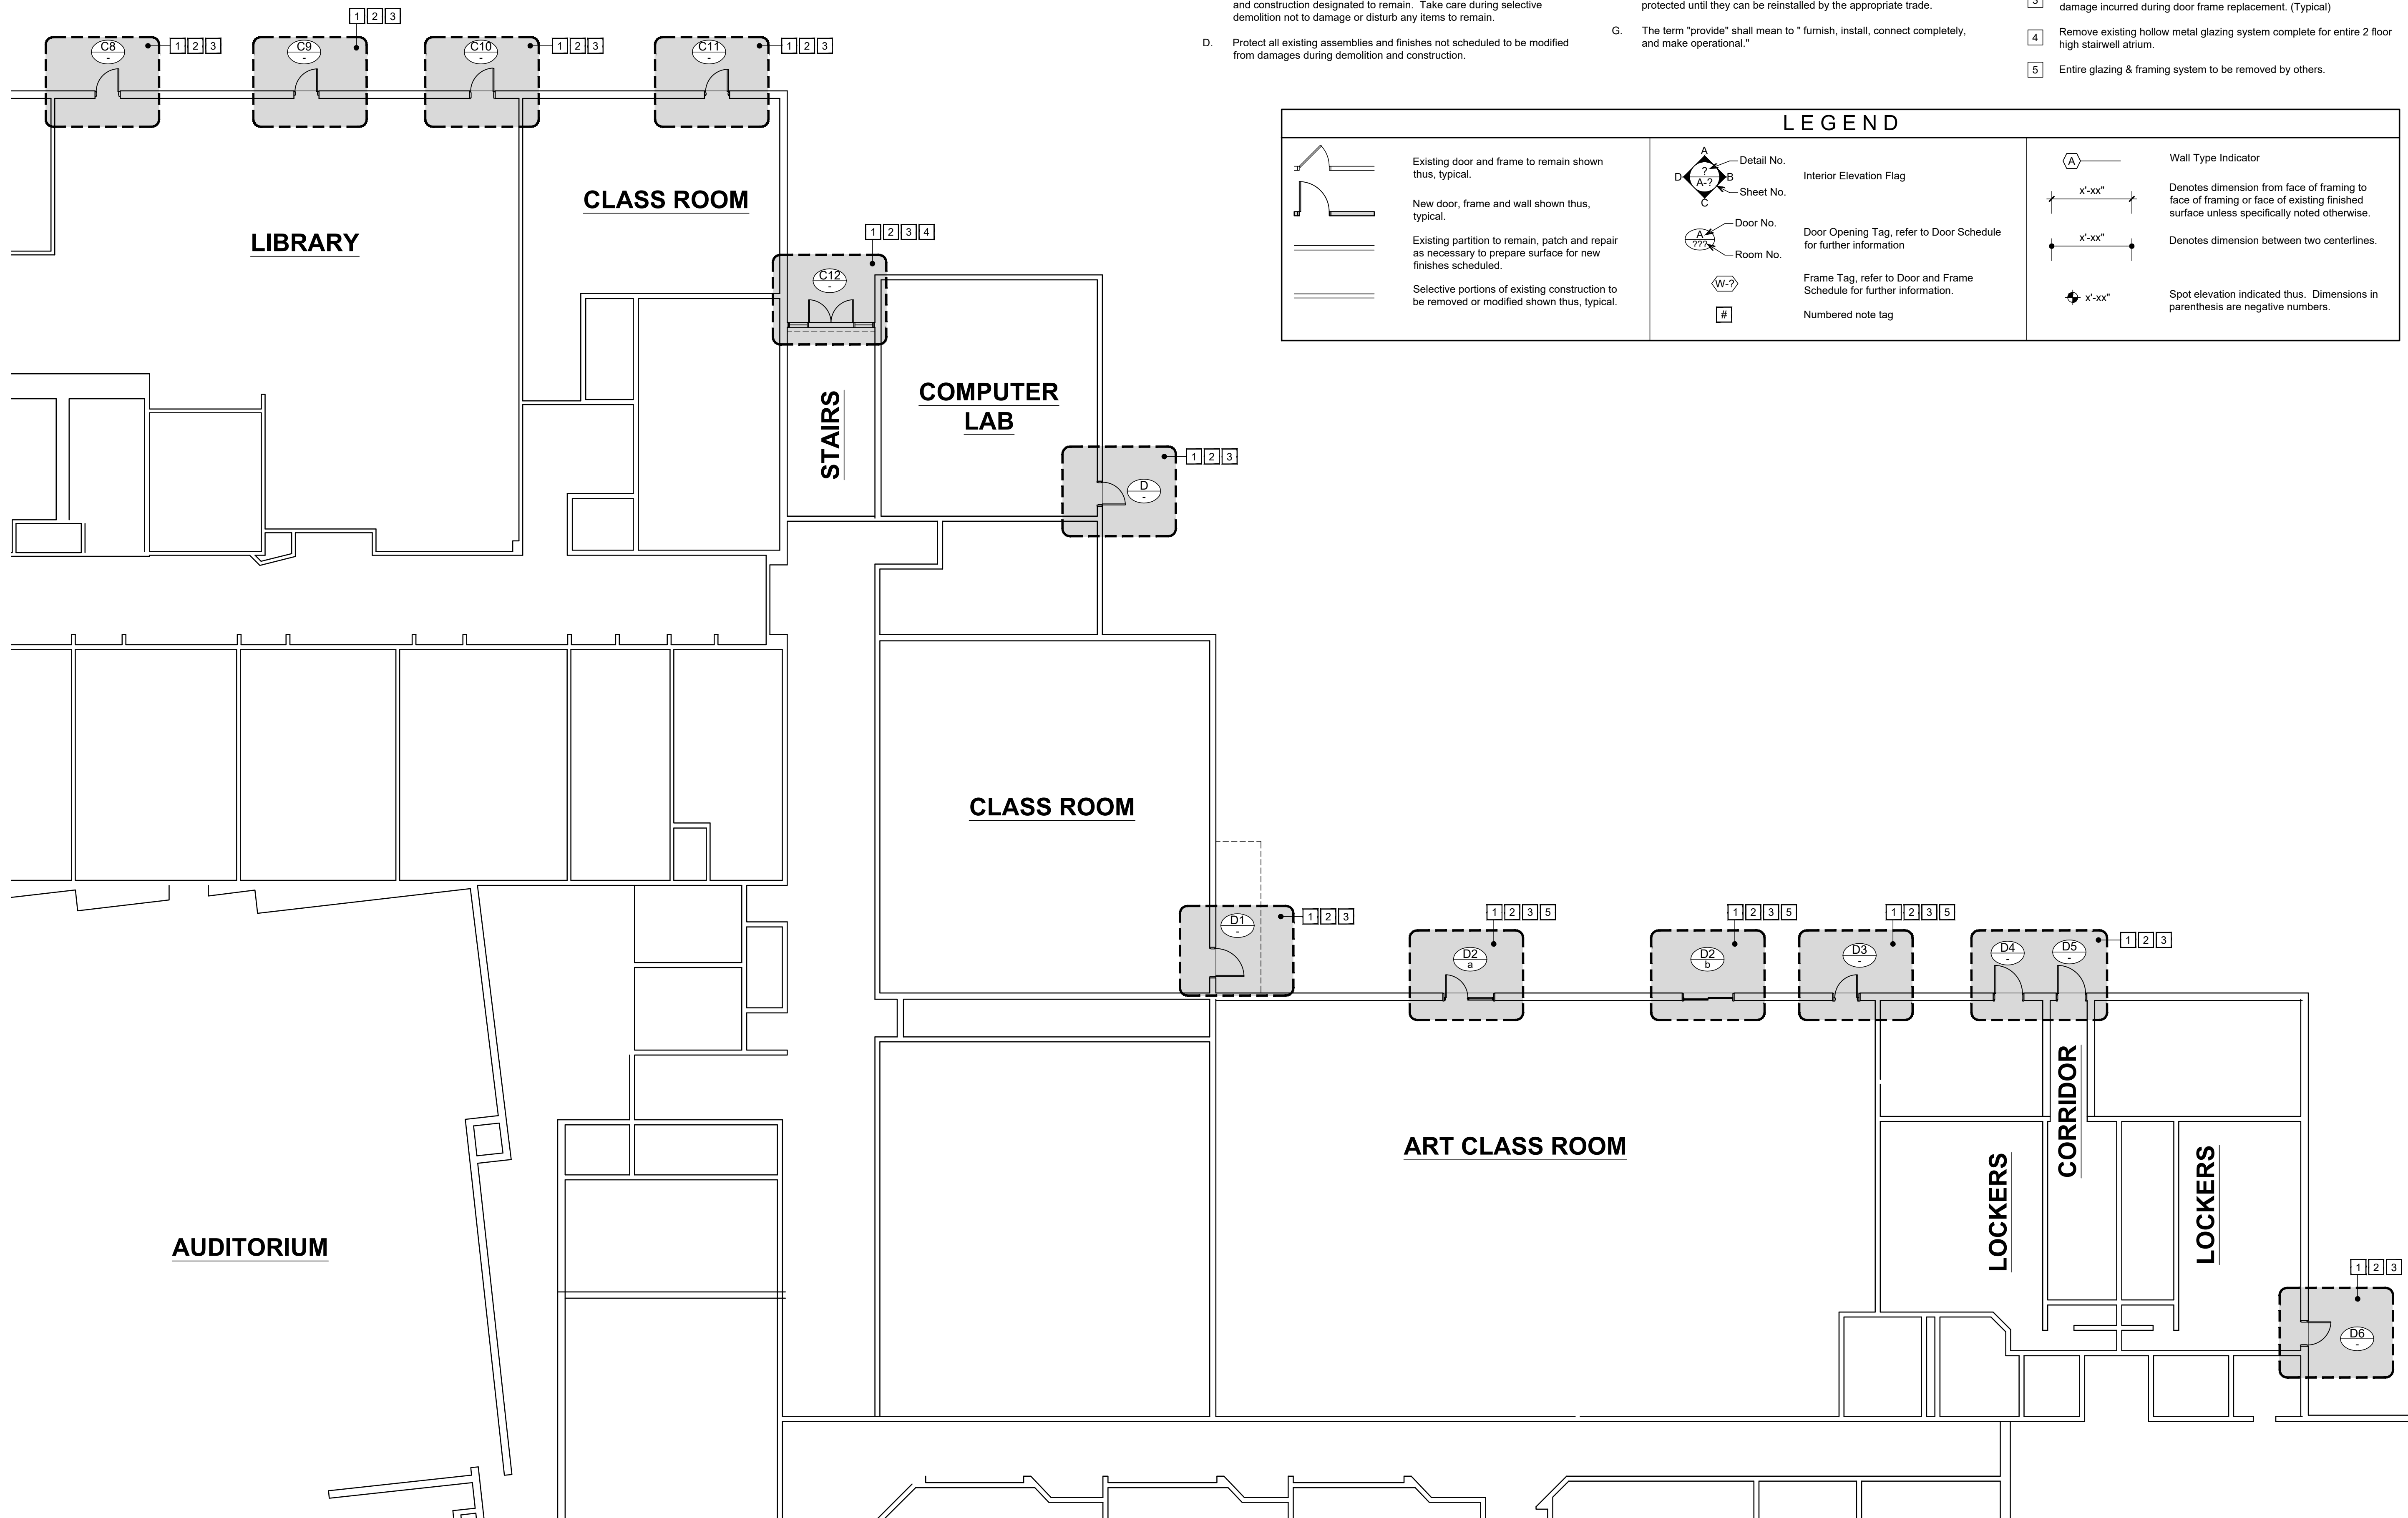

LEGEND			
	Existing door and frame to remain shown thus, typical.		Wall Type Indicator
	New door, frame and wall shown thus, typical.		Denotes dimension from face of framing to face of existing finished surface unless specifically noted otherwise.
	Existing partition to remain, patch and repair as necessary to prepare surface for new finishes scheduled.		Denotes dimension between two centerlines.
	Selective portions of existing construction to be removed or modified shown thus, typical.		Spot elevation indicated thus. Dimensions in parenthesis are negative numbers.
	Detail No.		
	Interior Elevation Flag		
	Sheet No.		
	Door No.		
	Room No.		
	Frame Tag, refer to Door and Frame Schedule for further information.		
	Numbered note tag		

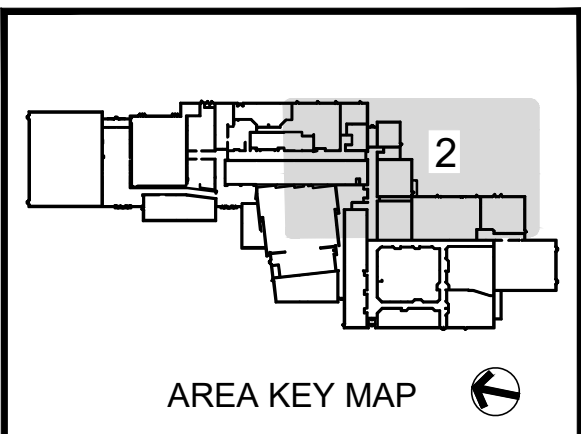

East Granby High School
Exterior Door Replacement
95 SOUTH MAIN STREET
EAST GRANBY, CT 06026

MAIER design group, llc.
architecture & interiors

34 Sequassen Street, Hartford, CT 06106
Tel: 860.293.0093 / Fax: 860.293.0094

AREA TWO PARTIAL PLAN


Project Number: 2024.013	Issue Date: Aug. 2, 2024
Scale: AS NOTED	CAD File: 24013_A101
Drawn By: mmap	Checked By: EAL

Revisions:

AREA TWO FLOOR PLAN

SCALE: 3/32" = 1'-0"

1

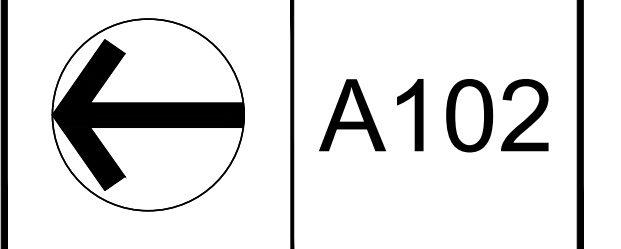


GENERAL NOTES:

- A. Refer to the Project Manual and the General Notes prior to beginning any work for further information regarding methods and materials.
- B. The Contractor shall thoroughly familiarize themselves with the Facility, the Drawings, the Project Manual prior to beginning any demolition. All work shall be coordinated with the designated town representative.
- C. Dashed lines indicate existing construction to be removed or modified. Exercise care during demolition activities to maintain adjacent spaces and construction designated to remain. Take care during selective demolition not to damage or disturb any items to remain.
- D. Protect all existing assemblies and finishes not scheduled to be modified from damages during demolition and construction.
- E. Patch and repair all existing surfaces and finishes intended to remain where damaged by demolition or construction activities. Patched surfaces to match and align with existing surfaces. Unfinished surfaces exposed by demolition or construction activities not specifically noted to receive new finishes shall be refinished to match nearest or adjacent similar surfaces.
- F. Exercise care to insure that all items designated in the drawings (or specified herein) to be reused are carefully removed, stored and protected until they can be reinstalled by the appropriate trade.
- G. The term "provide" shall mean to "furnish, install, connect completely, and make operational."


DRAWING KEY NOTES:

- 1 Existing door, frame and hardware to be removed complete. Door and frame to be discarded, hardware to be salvaged and returned to owner unless scheduled to be reused. (Typical)
- 2 Provide new doors and frames in existing rough opening. Refer to Door Schedule and Hardware Sets on sheet A200 for further information.
- 3 Patch & repair all adjacent surfaces as required to remediate any and all damage incurred during door frame replacement. (Typical)
- 4 Remove existing hollow metal glazing system complete for entire 2 floor high stairwell atrium.
- 5 Entire glazing & framing system to be removed by others.

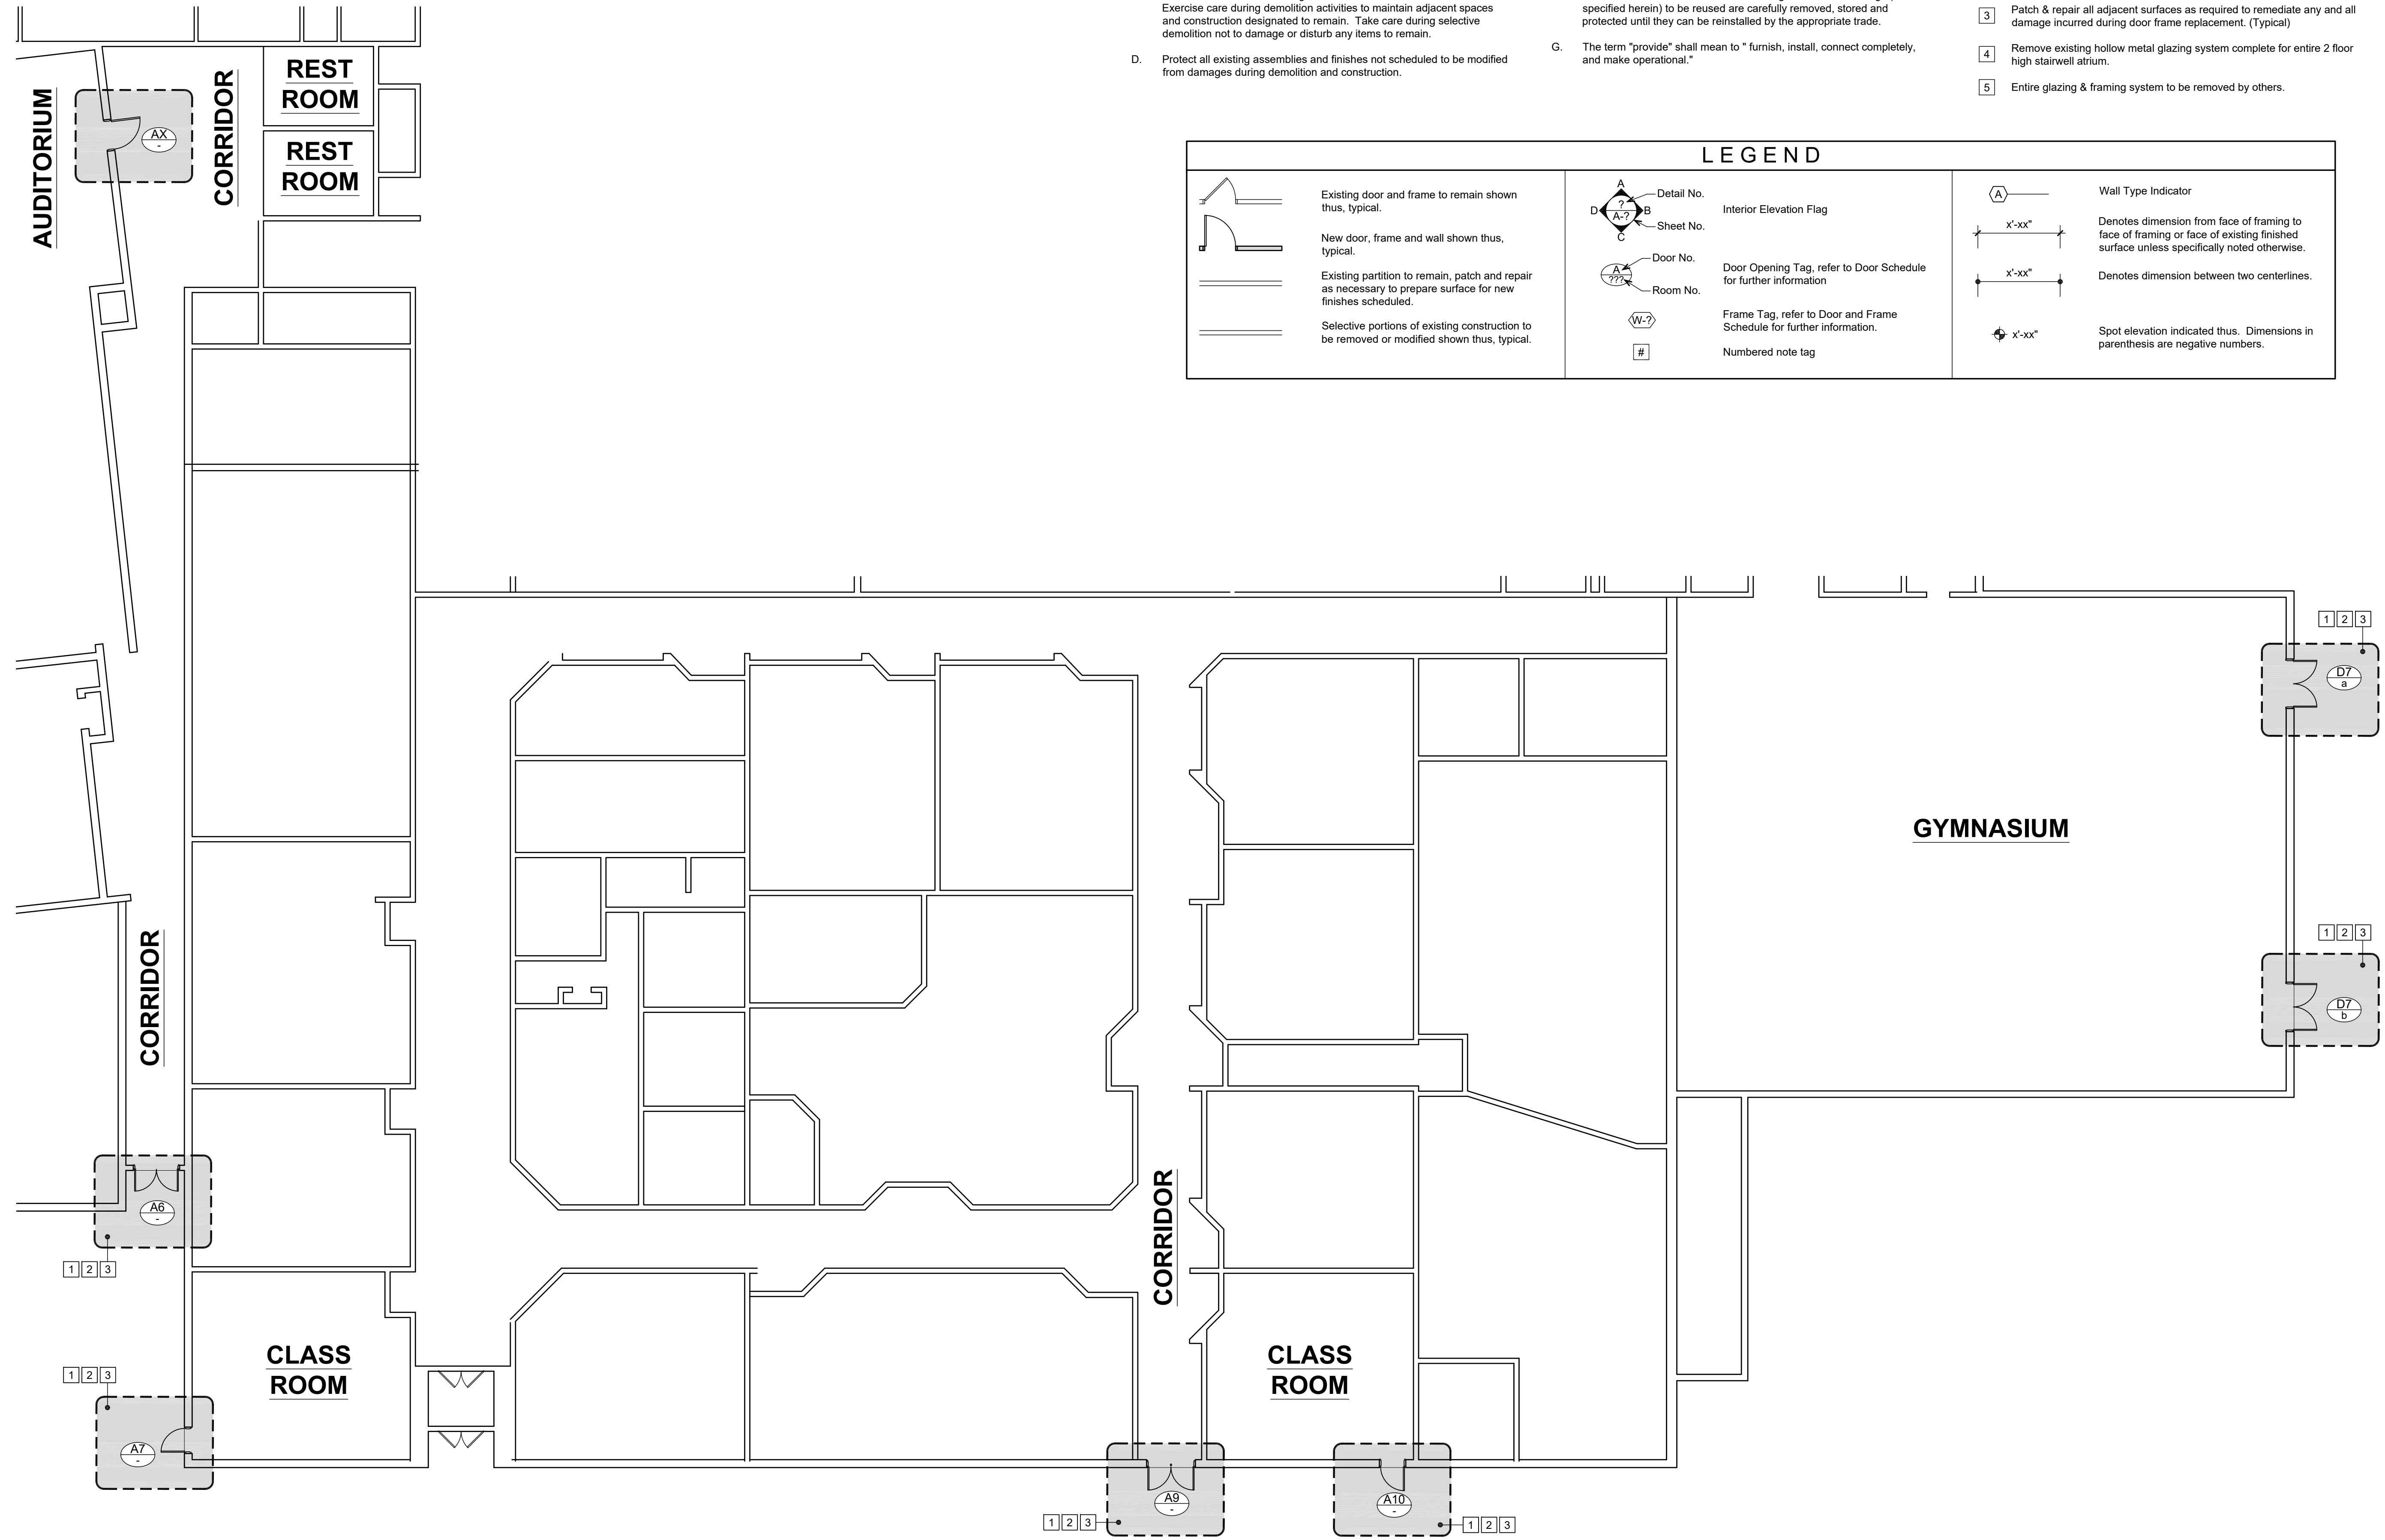

LEGEND

	Existing door and frame to remain shown thus, typical.		Detail No.		Wall Type Indicator
	New door, frame and wall shown thus, typical.		Sheet No.		Denotes dimension from face of framing to face of framing or face of existing finished surface unless specifically noted otherwise.
	Existing partition to remain, patch and repair as necessary to prepare surface for new finishes scheduled.		Door No.		Denotes dimension between two centerlines.
	Selective portions of existing construction to be removed or modified shown thus, typical.		Room No.		Spot elevation indicated thus. Dimensions in parenthesis are negative numbers.
			Frame Tag, refer to Door and Frame Schedule for further information.		
			Numbered note tag		

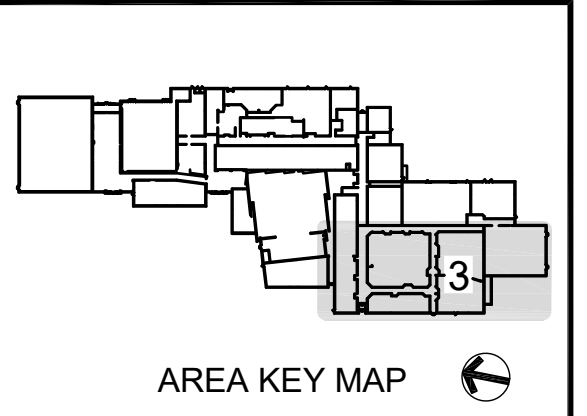

East Granby High School
Exterior Door Replacement
 95 SOUTH MAIN STREET
 EAST GRANBY, CT 06026

MAIER design group, llc.
architecture & interiors
 34 Sequassen Street, Hartford, CT 06106
 Tel: 860.293.0093 / Fax: 860.293.0094

AREA THREE FLOOR PLAN

Project Number: 2024.013	Issue Date: Aug. 2, 2024
Scale: AS NOTED	CAD File: 24013_A101
Drawn By: map	Checked By: EAL

Revisions:

AREA THREE FLOOR PLAN
 SCALE: 3/32" = 1'-0"


A103

HARDWARE SETS		
TAG	DESCRIPTION	DOORS
A	Continuous Hinge, ADA Compliant Overhead Closer, Reinstalled Electronic Keypad Lockset with Lever Handles on Both Sides, Weatherstripping, Bottom Sweep, Kickplate on Interior Side, ADA Compliant Threshold, Pickplate at Strike.	A1, A7, C2
B	Continuous Hinge, ADA Compliant Overhead Closer, Reinstalled Electronic Keypad Lockset with Lever Handle at Exterior, Rim Mounted Panic Device on Interior With Electric Latch Retraction, Weatherstripping, Bottom Sweep, Kickplate on Interior Side, ADA Compliant Threshold, Pickplate at Strike.	C6, D1
C	Continuous Hinge, ADA Compliant Overhead Closer, Cylinder Lockset with Lever Handles on Both Sides, Weatherstripping, Bottom Sweep, Kickplate on Interior Side, ADA Compliant Threshold, Pickplate at Strike.	D2a, D2b, D4
D	Continuous Hinge, ADA Compliant Overhead Closer, No Exterior Hardware, Rim Mounted Panic Device on Interior, Weatherstripping, Bottom Sweep, Kickplate on Interior Side, ADA Compliant Threshold, Pickplate at Strike.	C8, C9, C10, C11, D, D5
E	Continuous Hinge, ADA Compliant Overhead Closer, Lever Handle at Exterior, Rim Mounted Panic Device on Interior, Weatherstripping, Bottom Sweep, Kickplate on Interior Side, ADA Compliant Threshold, Pickplate at Strike.	A10
F	Continuous Hinge, ADA Compliant Overhead Closer, Reinstalled Electronic Keypad Lockset with Lever Handles at Exterior, Rim Mounted Panic Device With Electric Latch Retraction on Interior, Reinstalled Airphone, Weatherstripping, Bottom Sweep, Kickplate on Interior Side, ADA Compliant Threshold, Pickplate at Strike.	D3
G	Active Leaf: Continuous Hinge, ADA Compliant Overhead Closer, Reinstalled Electronic Keypad Lockset with Lever Handle on Exterior and Rim Mounted Panic Device on Interior With Electric Latch Retraction, Weatherstripping, Bottom Sweep, Kickplate on Interior Side, ADA Compliant Threshold, Pickplate at Strike. Inactive Leaf: Continuous Hinge, ADA Compliant Overhead Closer, Tubular Pull on Exterior and Rim Mounted Panic Device on Interior, Weatherstripping, Bottom Sweep, Kickplate on Interior Side, ADA Compliant Threshold, Pickplate at Strike.	C
H	Active Leaf: Continuous Hinge, ADA Compliant Overhead Closer, Reinstalled Electronic Keypad Lockset with Lever Handle on Exterior and Rim Mounted Panic Device on Interior With Electric Latch Retraction, Weatherstripping, Bottom Sweep, Kickplate on Interior Side, ADA Compliant Threshold, Pickplate at Strike. Inactive Leaf: Continuous Hinge, ADA Compliant Overhead Closer, Tubular Pull on Exterior and Rim Mounted Panic Device on Interior, Weatherstripping, Bottom Sweep, Kickplate on Interior Side, ADA Compliant Threshold, Pickplate at Strike. Removable Astragal Between Leaves.	A9, D7a
I	Each Leaf: Continuous Hinge, ADA Compliant Overhead Closer, No Exterior Hardware, Rim Mounted Panic Device on Interior, Weatherstripping, Bottom Sweep, Kickplate on Interior Side, ADA Compliant Threshold, Pickplate at Strike.	C1a, C1b
J	Each Leaf: Continuous Hinge, ADA Compliant Overhead Closer, No Exterior Hardware, Rim Mounted Panic Device on Interior, Weatherstripping, Bottom Sweep, Kickplate on Interior Side, ADA Compliant Threshold, Pickplate at Strike. Removable Astragal Between Leaves.	A6, C6, D7b
K	Active Leaf: Continuous Hinge, ADA Compliant Overhead Closer, Reinstalled Electronic Keypad Lockset with Lever Handle on Exterior and Rim Mounted Panic Device on Interior With Electric Latch Retraction, Weatherstripping, Bottom Sweep, Kickplate on Interior Side, ADA Compliant Threshold, Pickplate at Strike. Inactive Leaf: Continuous Hinge, ADA Compliant Overhead Closer, No Exterior Hardware and Rim Mounted Panic Device on Interior, Weatherstripping, Bottom Sweep, Kickplate on Interior Side, ADA Compliant Threshold, Pickplate at Strike.	C12


DOOR NOTES:

- No. 1 Verify all lockset functions with Owner and coordinate keying requirements with existing locksets.
- No. 2 Verify all throat and anchoring conditions in the field prior to ordering any frames.
- No. 3 Verify all existing rough opening dimensions prior to ordering any frames.

DOOR SCHEDULE - EAST GRANBY H.S.															
Area One															
Door Tag	Location	Elevation	Width (W)	Height (H)	Material	Door Finish	Frame Type	Frame Depth	Jamb Detail	Head Detail	Frame Finish	Hardware	Function	Rating	Notes
A1	Main Office	DR-1	2'-11"	6'-11"	HM	PAINT	FR-1	10"	1 / A201	1 / A201	PAINT	A	ENTRY	N/A	
C	Vestibule (Gymnasium)	DR-7	2 @ 3'-0"	7'-0"	HM/GLASS	PAINT	FR-5	12 1/2"	1 / A201	2 / A201	PAINT	G	EGRESS	N/A	
C1a	Gymnasium 2	DR-2	3 @ 3'-0"	7'-0"	HM/GLASS	PAINT	FR-6	16"	1 / A201	1 / A201	PAINT	I	EGRESS	N/A	
C1b	Gymnasium 2	DR-2	3 @ 3'-0"	7'-0"	HM/GLASS	PAINT	FR-6	16"	1 / A201	1 / A201	PAINT	I	EGRESS	N/A	
C2	Supply	DR-1	3'-9"	7'-8"	HM	PAINT	FR-1	12 1/2"	1 / A201	1 / A201	PAINT	A	EGRESS	N/A	
C6	Corridor	DR-5	2 @ 2'-5"	7'-7"	HM	PAINT	FR-4	7"	1 / A201	1 / A201	PAINT	B	EGRESS	N/A	
Area Two															
C8	Library	DR-1	3'-0"	7'-0"	HM	PAINT	FR-1	9"	1 / A201	1 / A201	PAINT	D	EGRESS	N/A	
C9	Library	DR-1	3'-0"	7'-0"	HM	PAINT	FR-1	6"	1 / A201	1 / A201	PAINT	D	EGRESS	N/A	
C10	Library	DR-1	3'-1"	7'-8"	HM	PAINT	FR-1	12 1/2"	1 / A201	1 / A201	PAINT	D	EGRESS	N/A	
C11	Classroom	DR-1	3'-0"	7'-0"	HM	PAINT	FR-1	6"	1 / A201	1 / A201	PAINT	D	EGRESS	N/A	
C12	Corridor (2 Stories)	DR-7	2 @ 3'-0"	7'-7"	ALUM / GLASS	ANODIZED	FR-8	6"	SEE FR-8	SEE FR-8	ANODIZED	K	EGRESS	N/A	
D	Maintenance Shop	DR-1	3'-0"	7'-0"	HM	PAINT	FR-1	9 1/2"	1 / A201	1 / A201	PAINT	D	EGRESS	N/A	
D1	Tech Ed.	DR-1	3'-9"	7'-6"	HM	PAINT	FR-1	16"	1 / A201	1 / A201	PAINT	B	EGRESS	N/A	
D2a	Art	DR-8	3'-0"	7'-6"	ALUM / GLASS	ANODIZED	FR-7a	12 1/2"	9 / A201	SEE FR-7a	SEE FR-7a	C	ENTRY	N/A	
D2b	Art	N/A	N/A	N/A	ALUM / GLASS	ANODIZED	FR-7b	12 1/2"	14 / A201	SEE FR-7b	SEE FR-7b	N/A	N/A	N/A	
D3	Art	DR-4	3'-0"	7'-6"	HM/GLASS	PAINT	FR-1	12 1/2"	1 / A201	1 / A201	PAINT	F	EGRESS	N/A	
D4	Supply	DR-1	3'-9"	7'-8"	HM	PAINT	FR-1	12 1/2"	1 / A201	1 / A201	PAINT	C	ENTRY	N/A	
D5	Supply	DR-1	3'-9"	7'-8"	HM	PAINT	FR-1	12 1/2"	1 / A201	1 / A201	PAINT	D	EGRESS	N/A	
D6	Locker	DR-1	3'-1"	7'-8"	HM	PAINT	FR-1	12 1/2"	1 / A201	1 / A201	PAINT	J	EGRESS	N/A	
Area Three															
D7a	Gymnasium	DR-5	2 @ 3'-0"	7'-8"	HM	PAINT	FR-4	12 1/2"	1 / A201	1 / A201	PAINT	H	EGRESS	N/A	
D7b	Gymnasium	DR-5	2 @ 3'-0"	7'-8"	HM	PAINT	FR-4	12 1/2"	1 / A201	1 / A201	PAINT	J	EGRESS	N/A	
A6	Corridor	DR-6	2 @ 3'-0"	7'-6"	HM/GLASS	PAINT	FR-4	7"	1 / A201	1 / A201	PAINT	J	EGRESS	N/A	
A7	Classroom	DR-1	3'-1"	7'-8"	HM	PAINT	FR-1	10"	1 / A201	1 / A201	PAINT	A	ENTRY	N/A	
A9	Corridor	DR-5	2 @ 3'-0"	7'-6"	HM	PAINT	FR-4	10 1/2"	1 / A201	1 / A201	PAINT	H	EGRESS	N/A	
A10	Classroom	DR-1	3'-1"	7'-7"	HM	PAINT	FR-1	12 1/2"	1 / A201	1 / A201	PAINT	E	EGRESS	N/A	

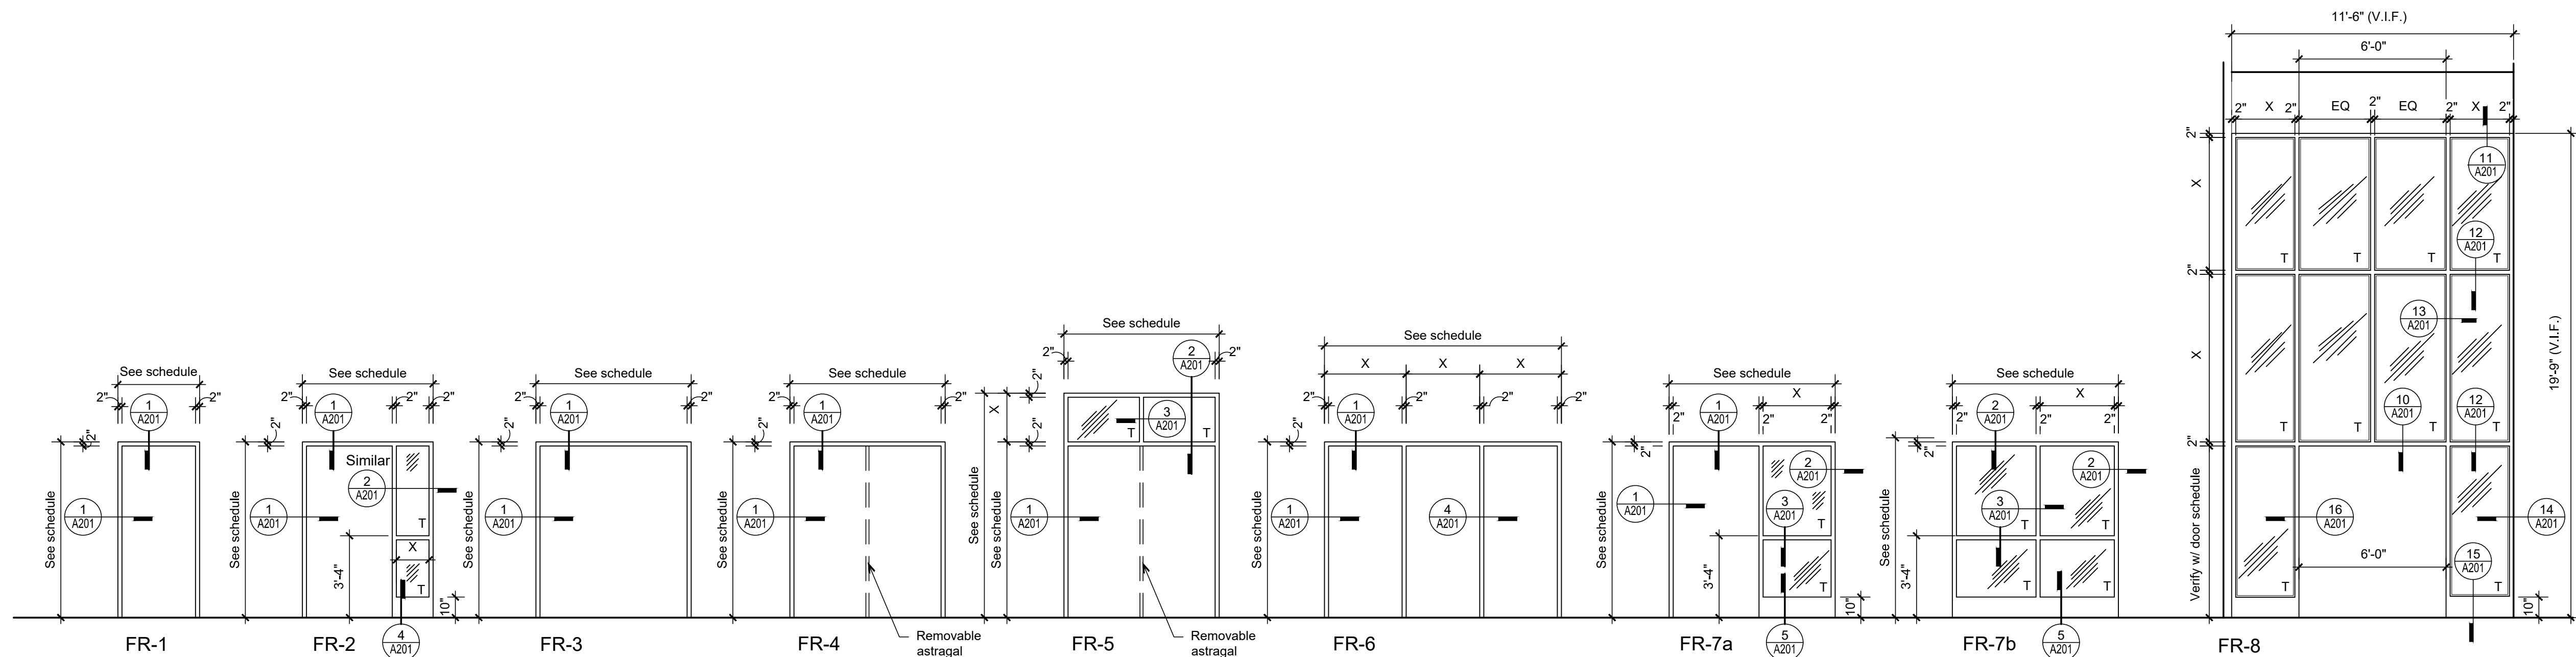

FRAME TYPE ELEVATIONS NOTE: T = *Tempered glass*
SCALE: 1/4"=1'-0"

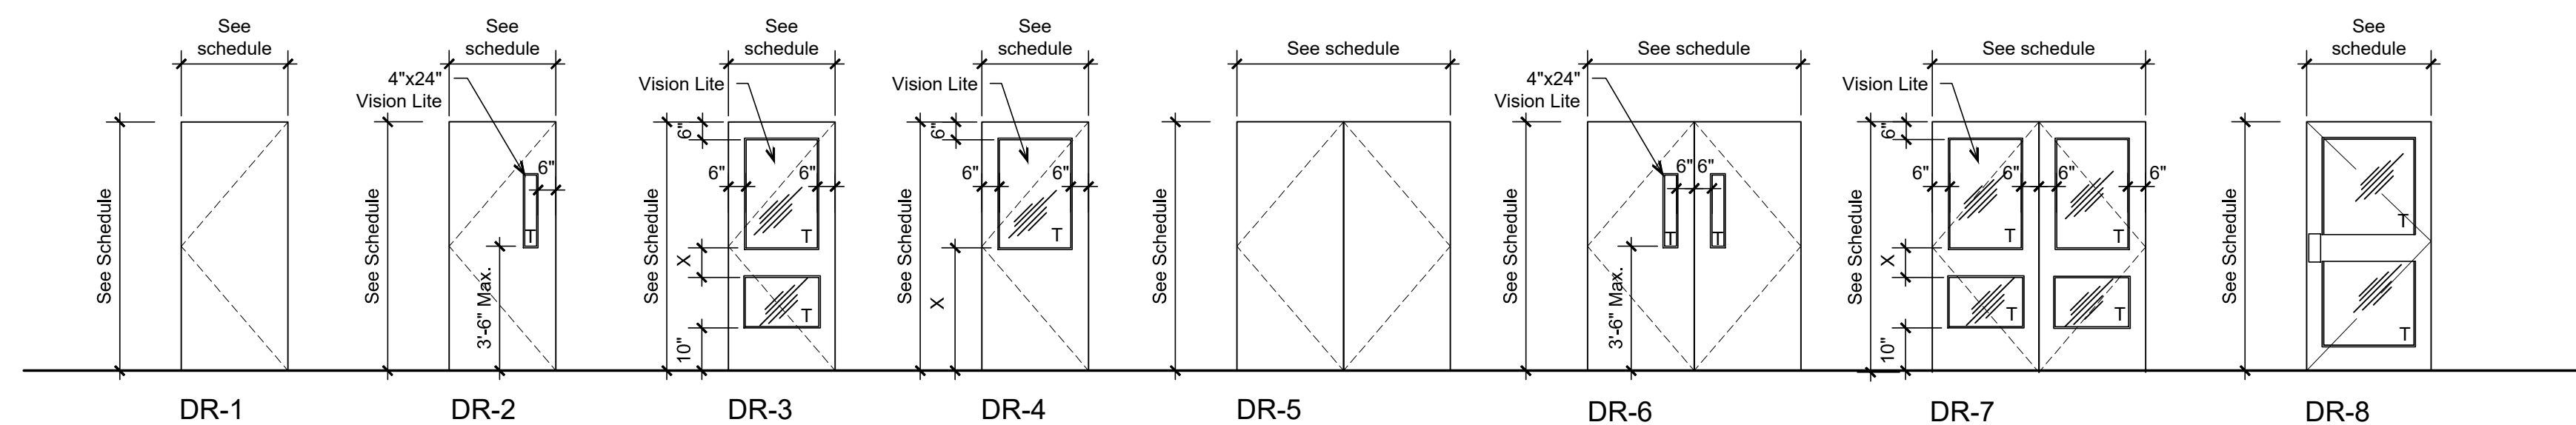

DOOR TYPE ELEVATIONS NOTE: T = *Tempered glass*
SCALE: 1/4"=1'-0"

East Granby High School
Exterior Door Replacement
95 SOUTH MAIN STREET
EAST GRANBY, CT 06026


MAIER design group, llc.
architecture & interiors


34 Sequassen Street, Hartford, CT 06106
Tel: 860.293.0093 / Fax: 860.293.0094

DOOR SCHEDULE AND ELEVATIONS


Project Number: 2024.013 Issue Date: Aug. 2, 2024
Scale: AS NOTED CAD File: 24013_A200
Drawn By: mmp Checked By: EAL

Revisions:

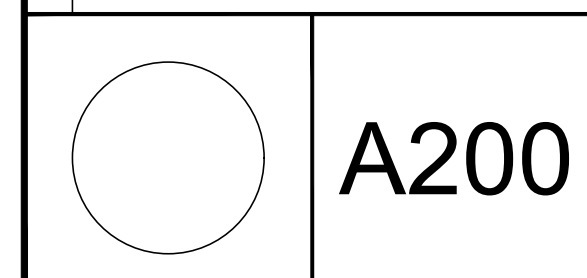


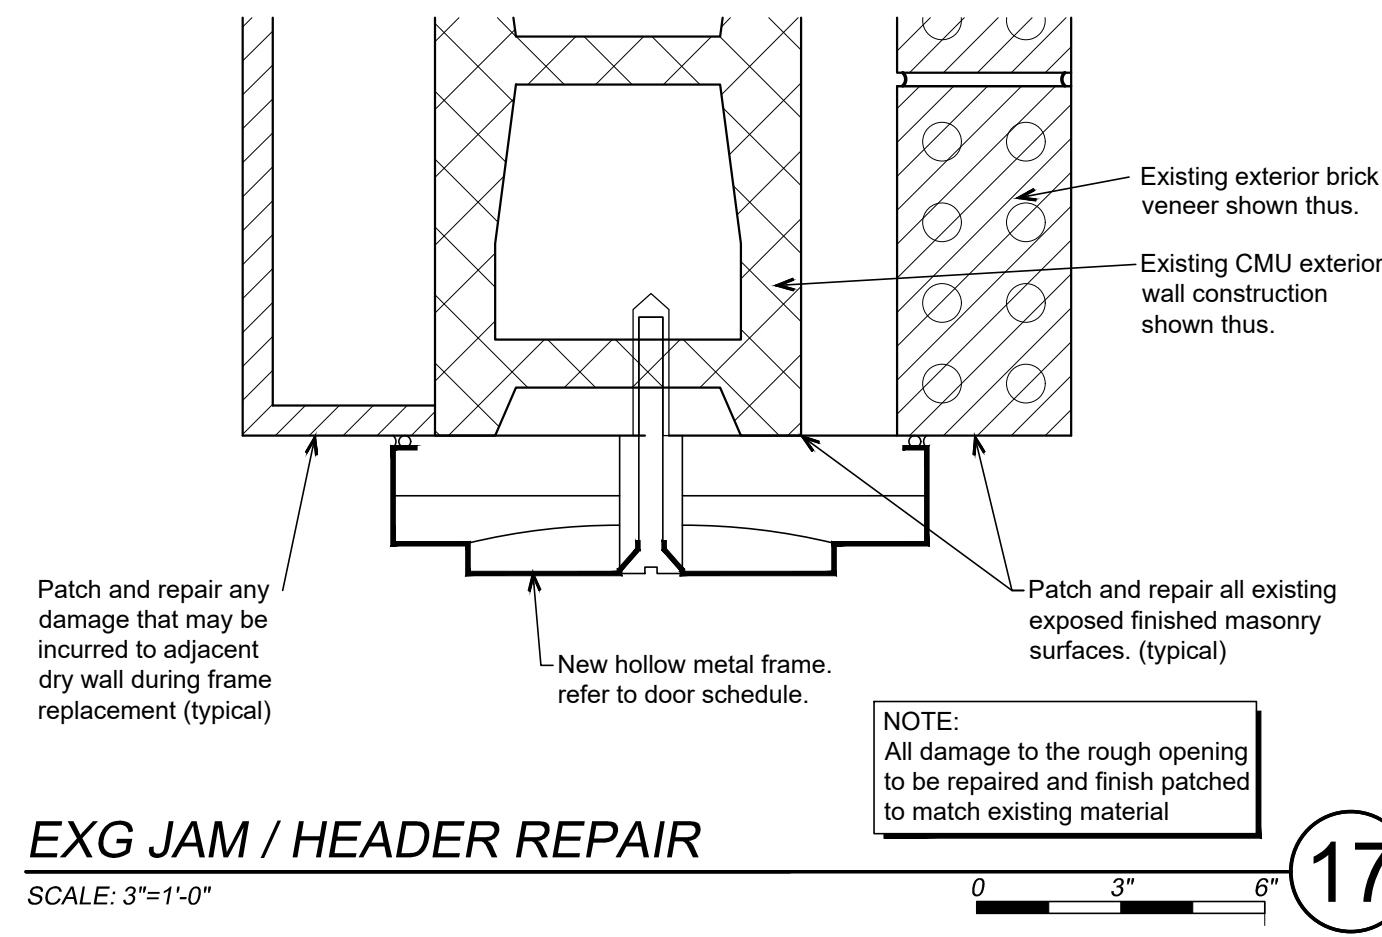


EXG JAM / HEADER REPAIR
SCALE: 3"=1'-0" 17

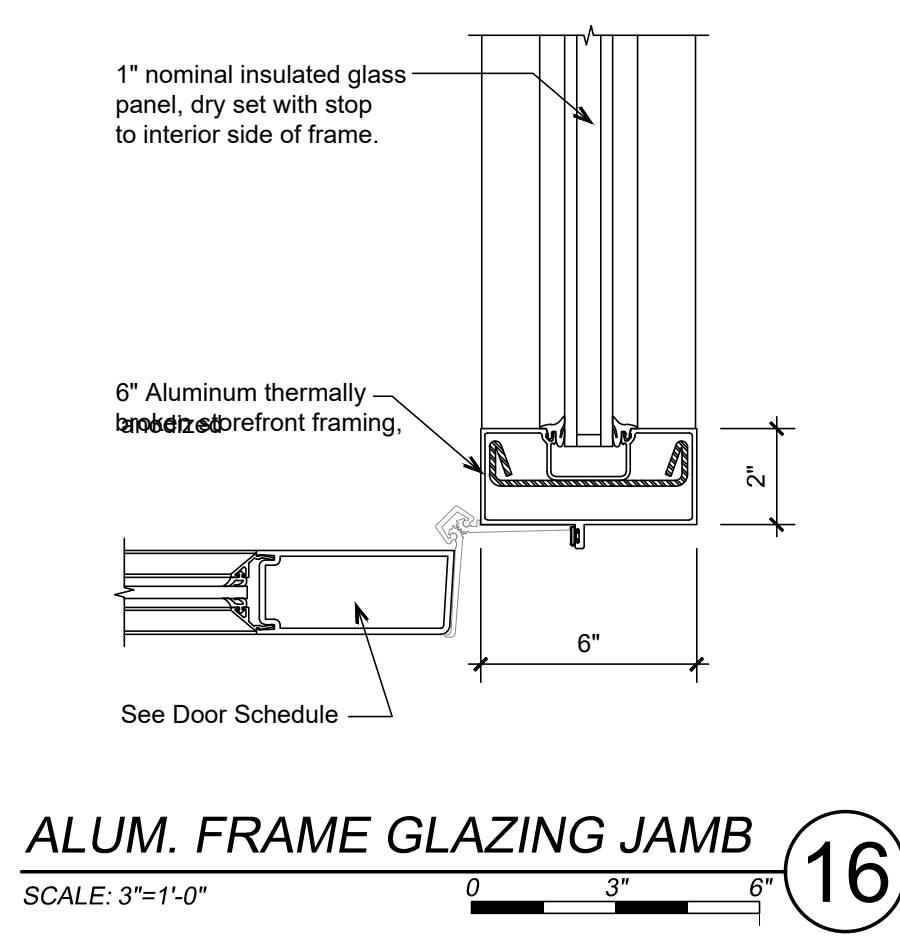


ALUM. FRAME GLAZING JAMB
SCALE: 3"=1'-0" 16

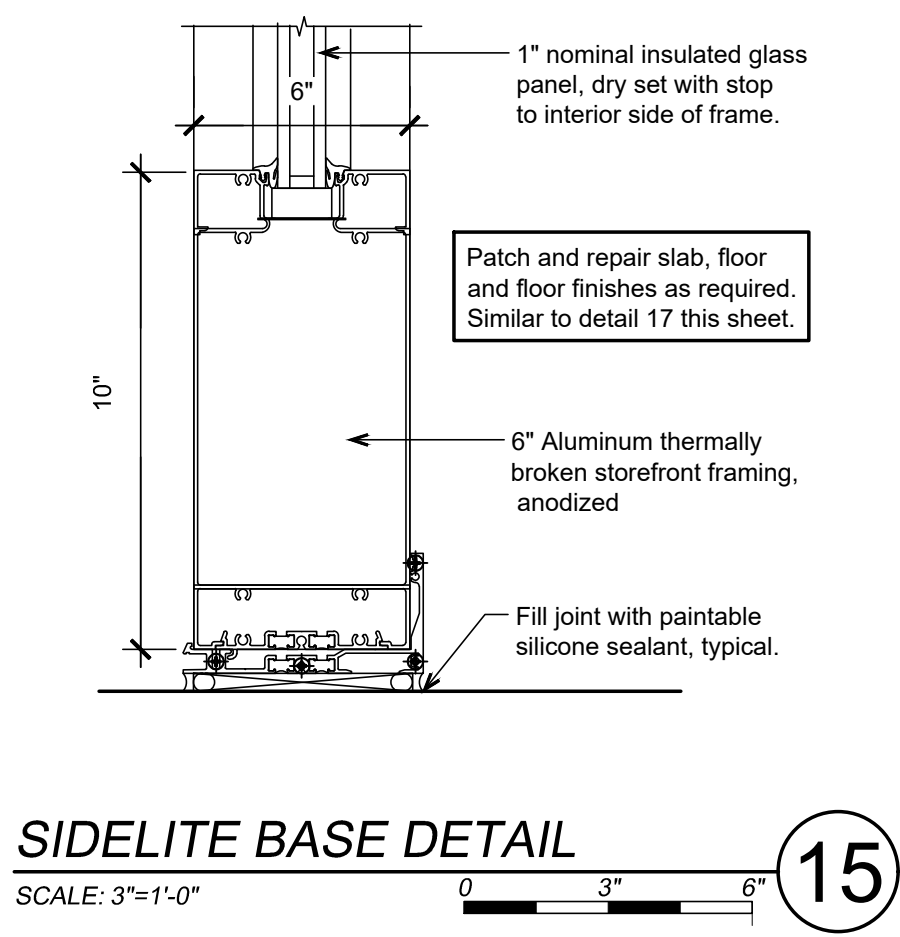


SIDELITE BASE DETAIL
SCALE: 3"=1'-0" 15

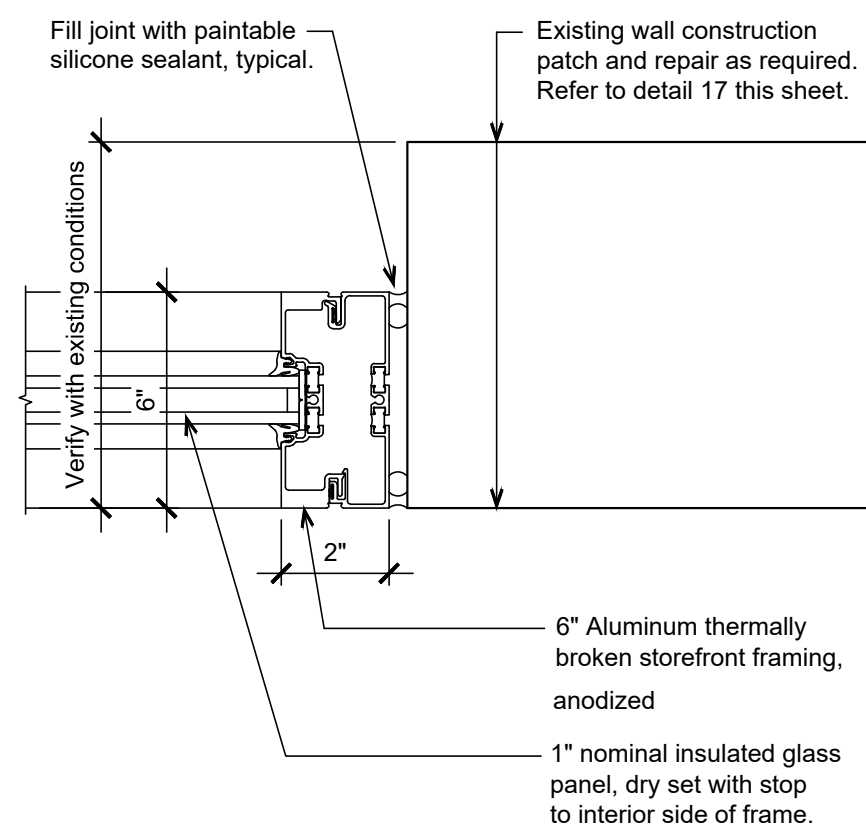


GLAZING JAMB DETAIL
SCALE: 3"=1'-0" 14

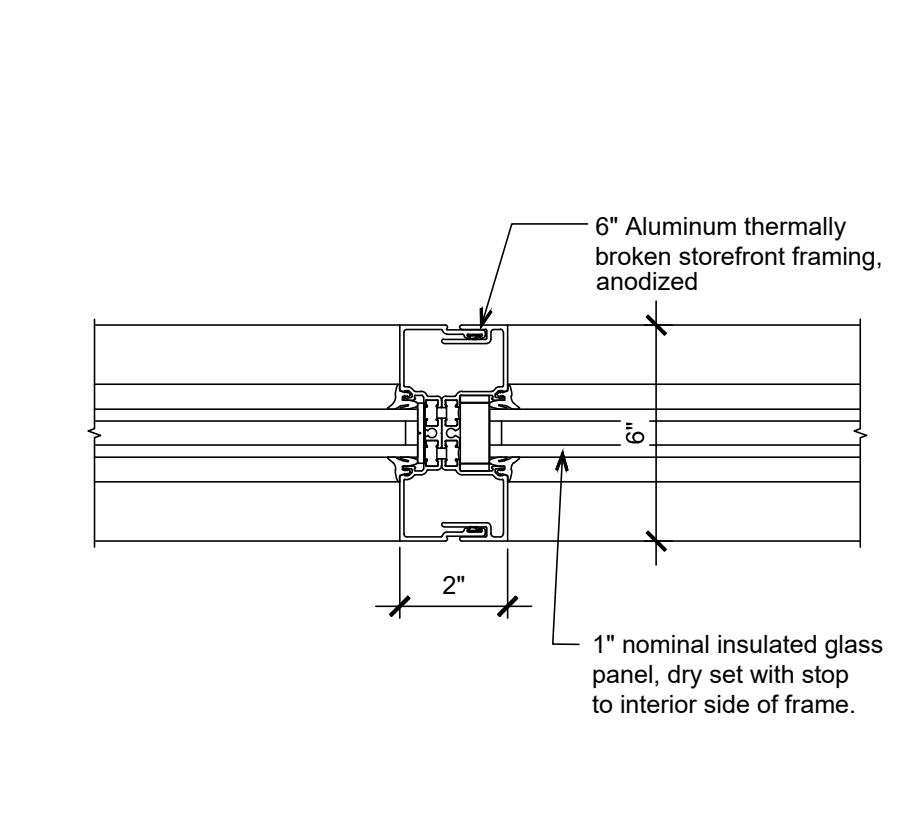


VERTICAL MULLION DETAIL
SCALE: 3"=1'-0" 13

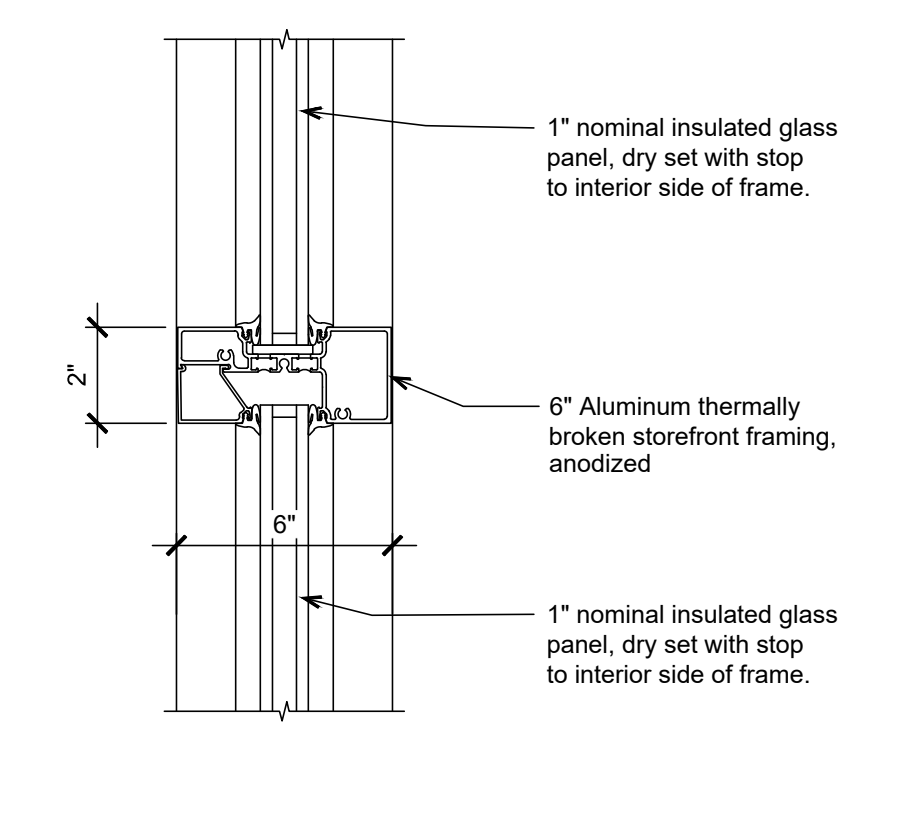


HORIZONTAL MULLION DETAIL
SCALE: 3"=1'-0" 12

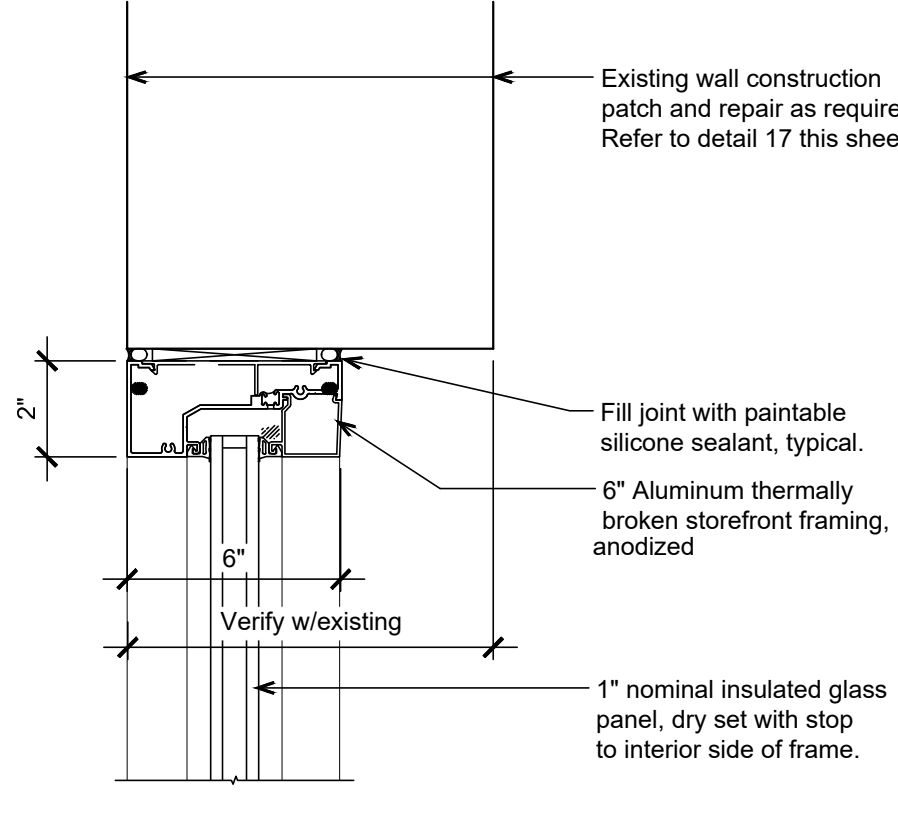


TRANSOM HEAD DETAIL
SCALE: 3"=1'-0" 11

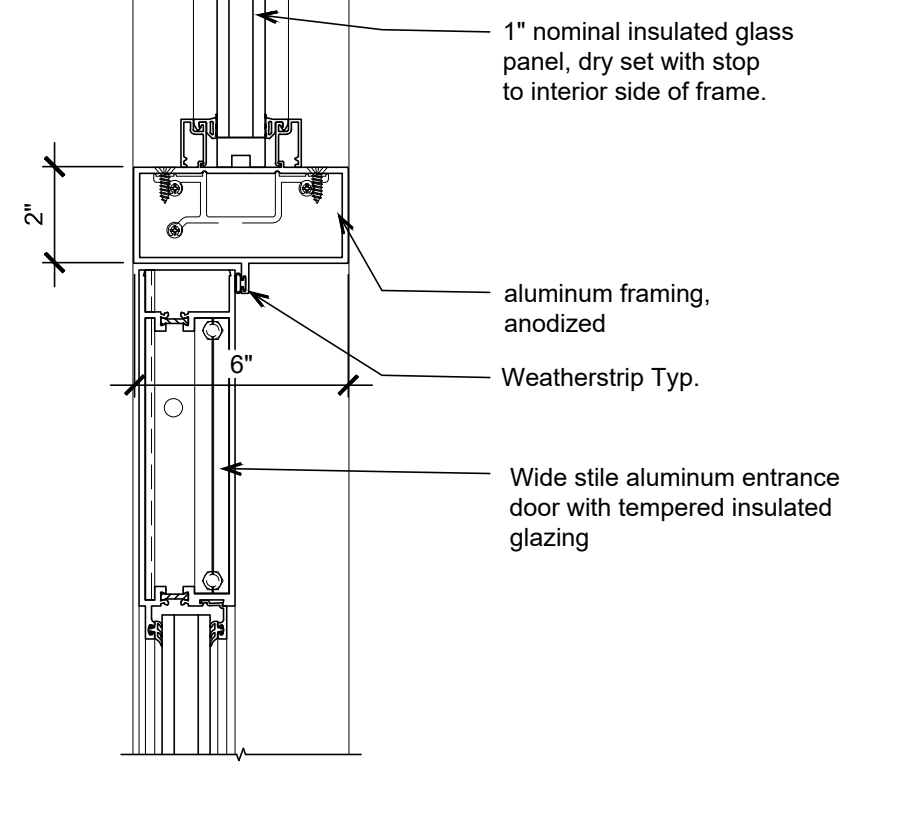


STOREFRONT TRANSOM
SCALE: 3"=1'-0" 10

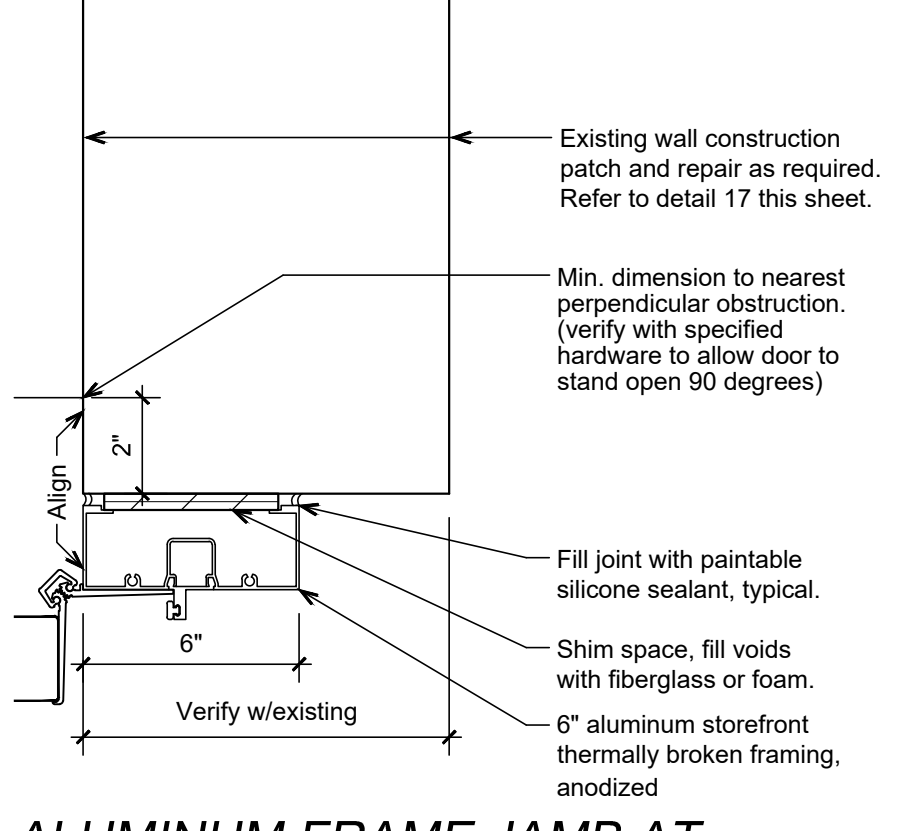


ALUMINUM FRAME JAMB AT MASONRY WALL (HEAD SIM.)
SCALE: 3"=1'-0" 9

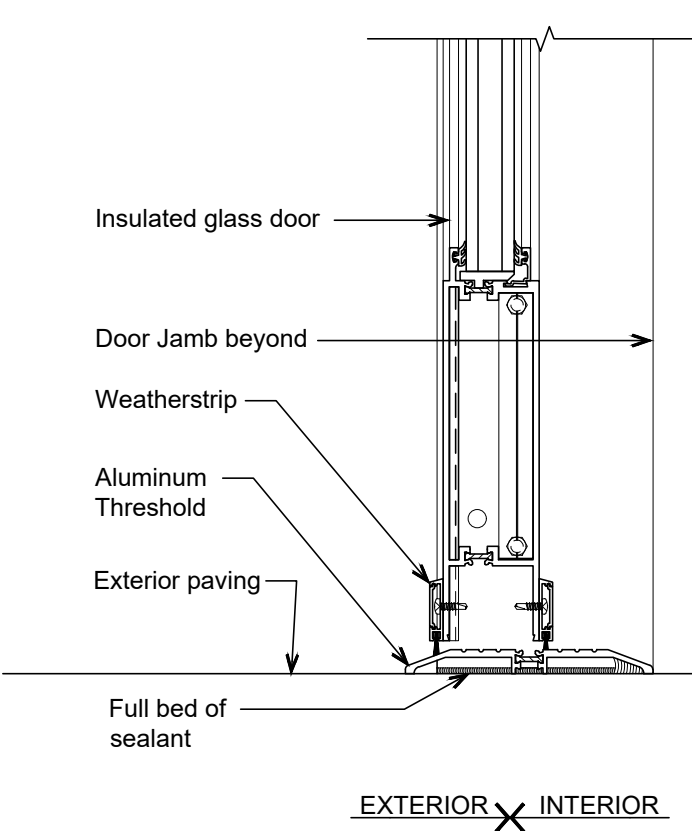


THRESHOLD DETAIL
SCALE: 3"=1'-0" 8

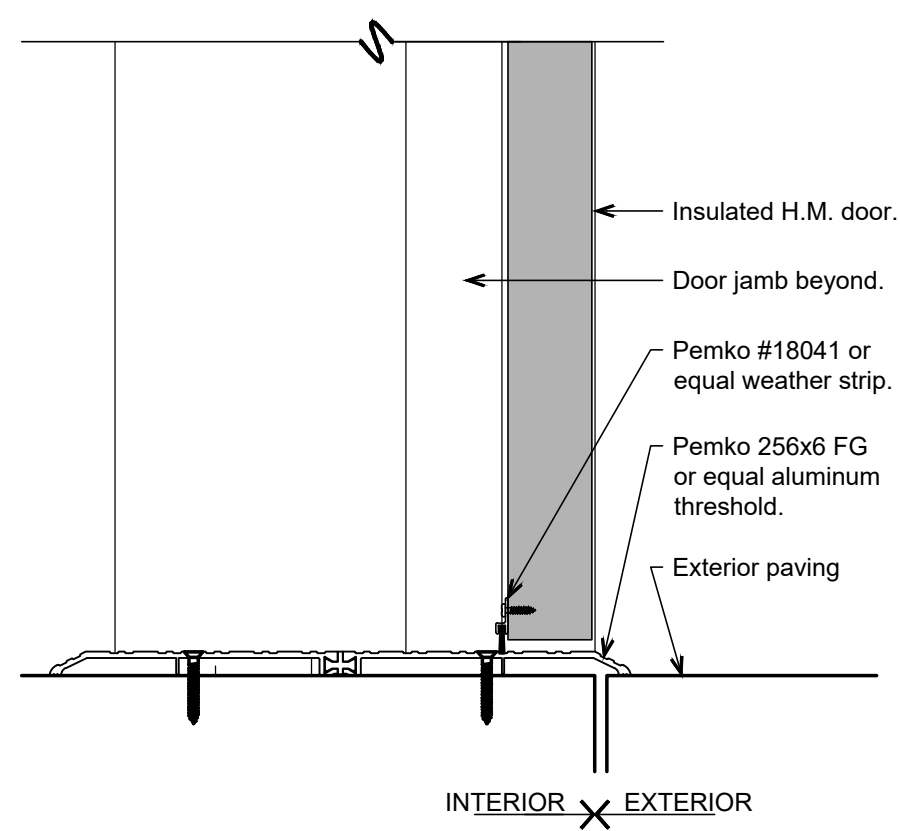


THRESHOLD DETAIL
SCALE: 3"=1'-0" 7

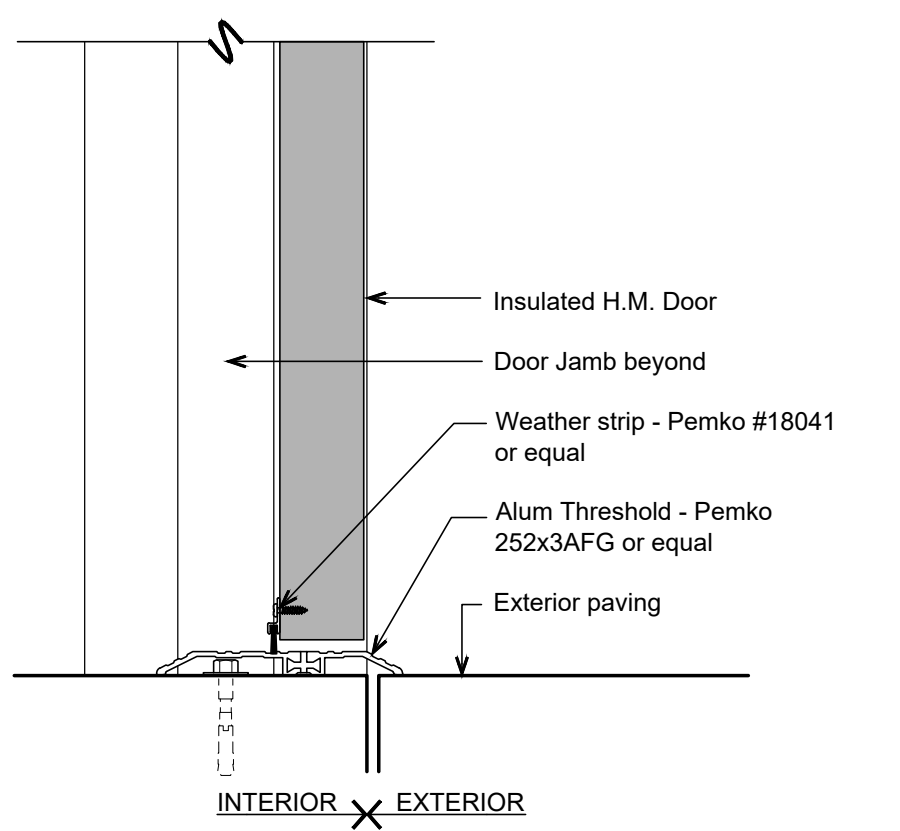


THRESHOLD DETAIL
SCALE: 3"=1'-0" 6

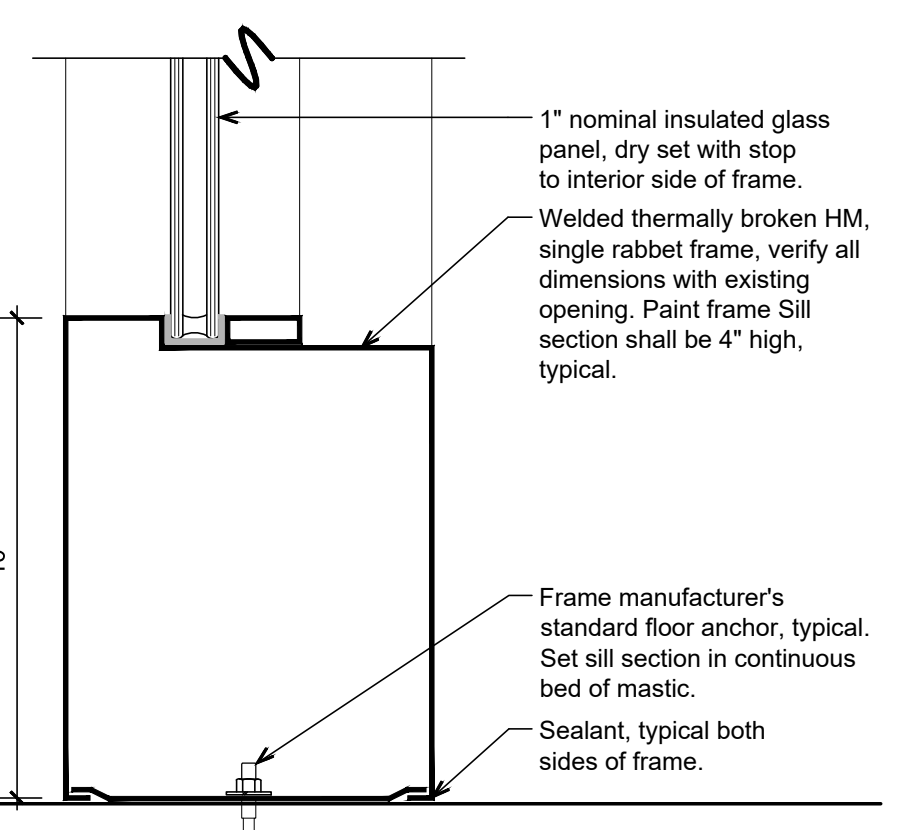


SIDELIGHT SILL DETAIL
SCALE: 3"=1'-0" 5

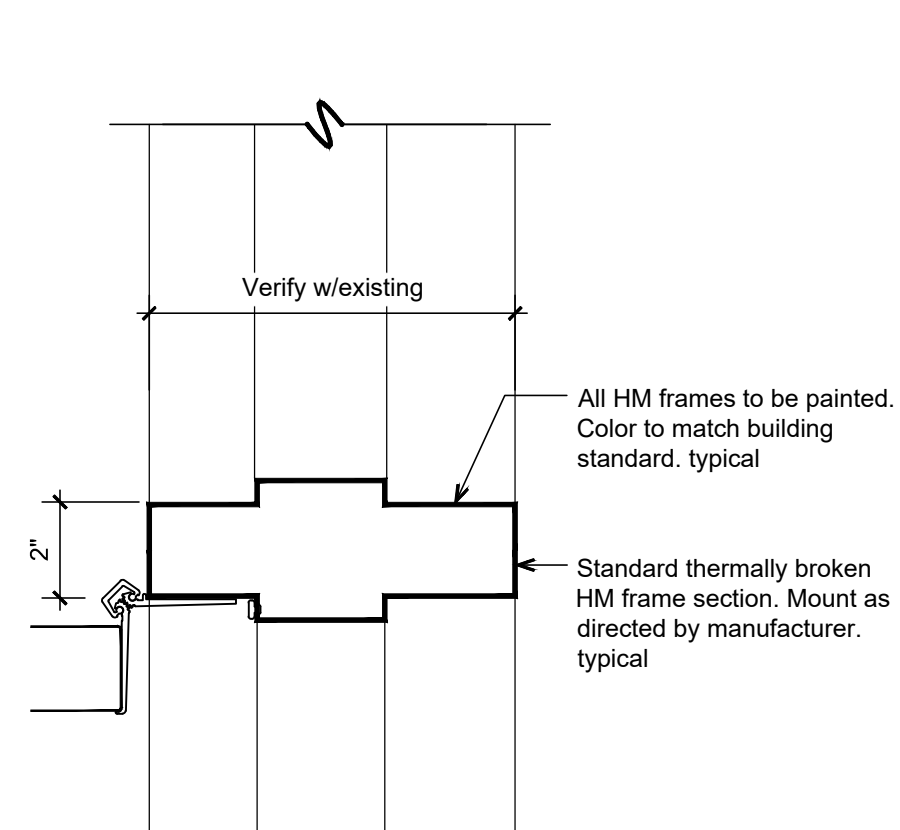


HM FRAME MULTI - JAMB
SCALE: 3"=1'-0" 4

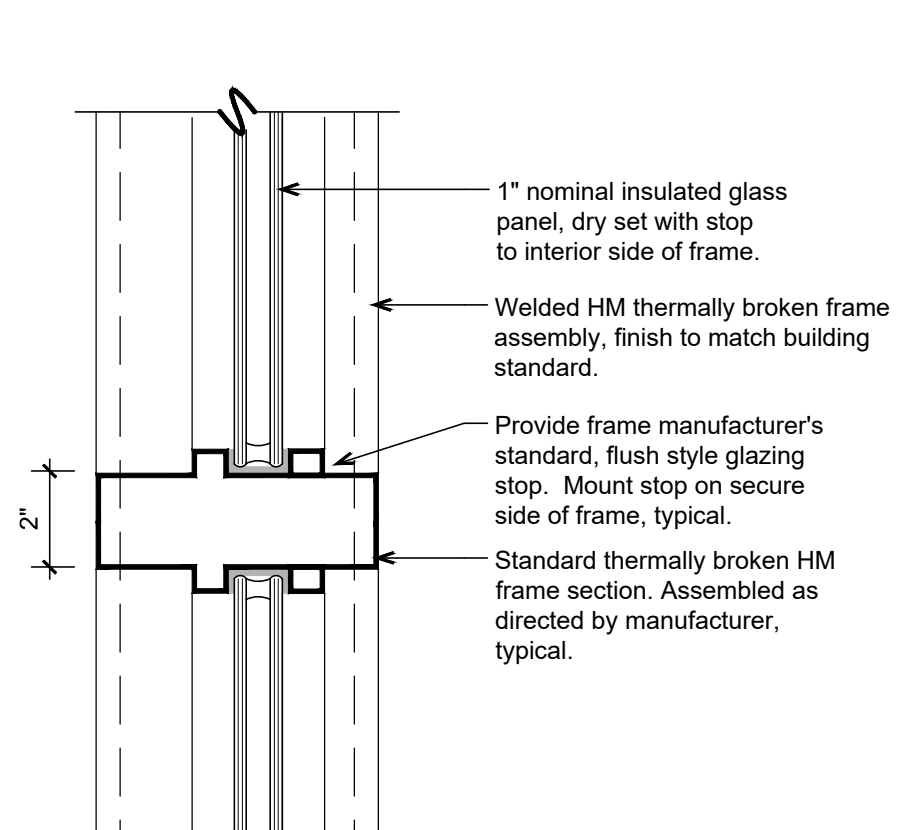

H.M. WINDOW MULLION DETAIL
SCALE: 3"=1'-0" 3

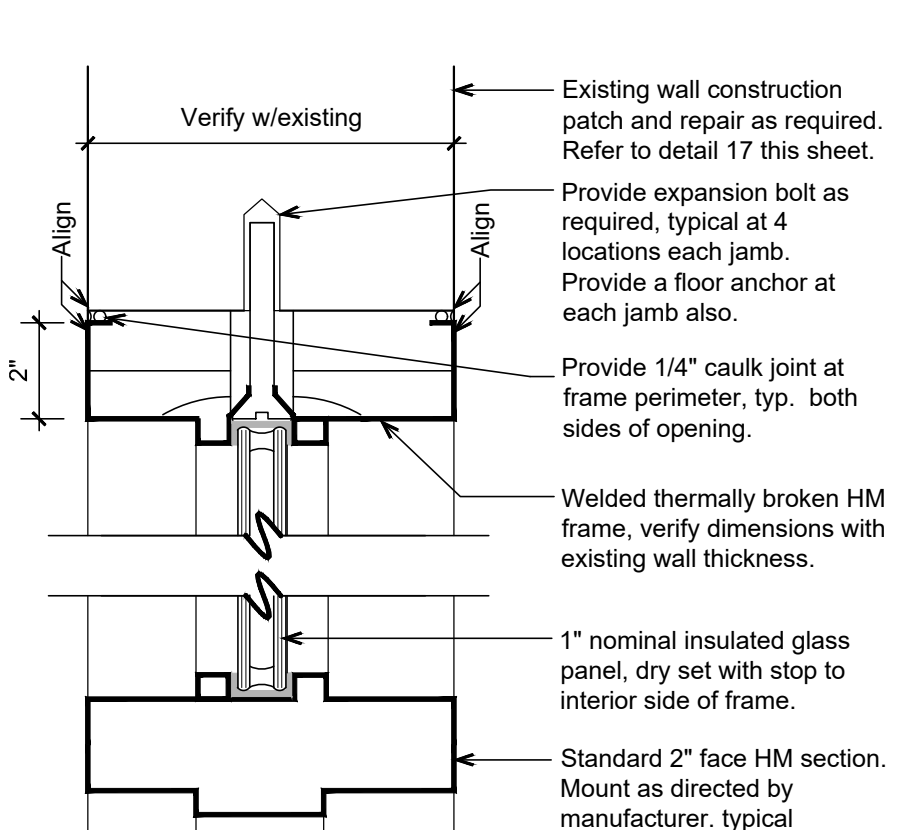

HM FRAME JAMB AT EXISTING MASONRY WALL (HEAD SIM.)
SCALE: 3"=1'-0" 2

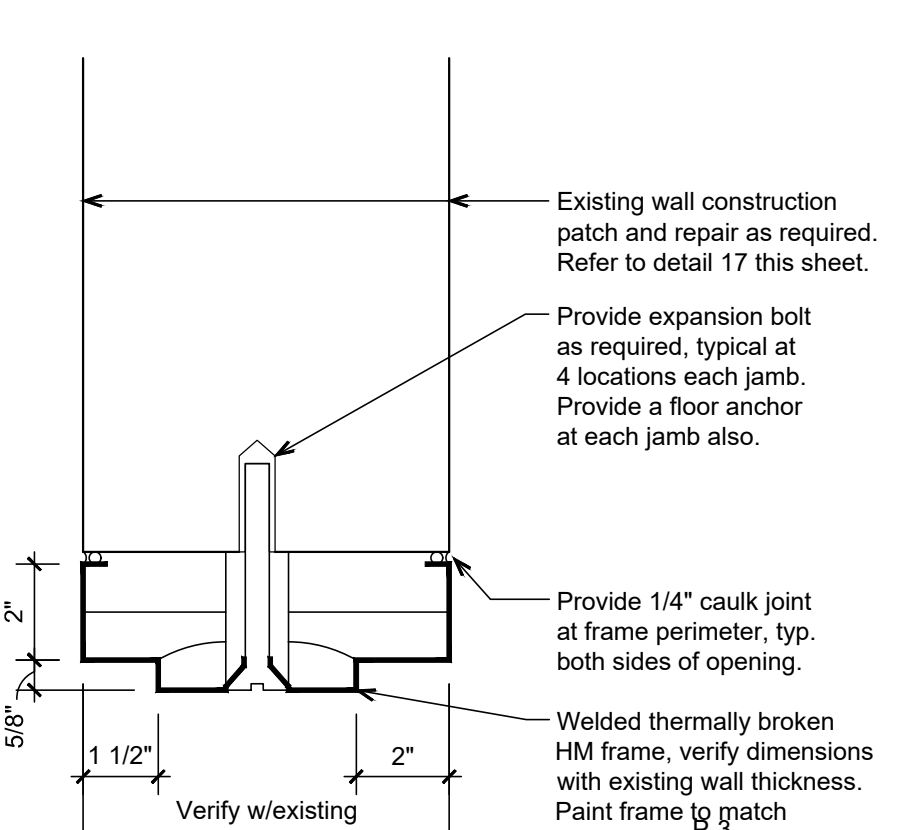

HM FRAME JAMB AT EXISTING MASONRY WALL (HEAD SIM.)
SCALE: 3"=1'-0" 1

East Granby High School
Exterior Door Replacement
95 SOUTH MAIN STREET
EAST GRANBY, CT 06026

MAIER design group, llc.
architecture & interiors

34 Sequassen Street, Hartford, CT 06106
Tel: 860.293.0093 / Fax: 860.293.0094

Project Number: 2024.013 Issue Date: Aug. 2, 2024
Scale: AS NOTED CAD File: 24013_A201
Drawn By: map Checked By: EAL

Revisions:

A201